PHASE 1 & 2

OWNER
GOLDEN POND FARMS INC.
P.O. BOX 357133
GAINESVILLE, FL. 32635
(352) 318-8880

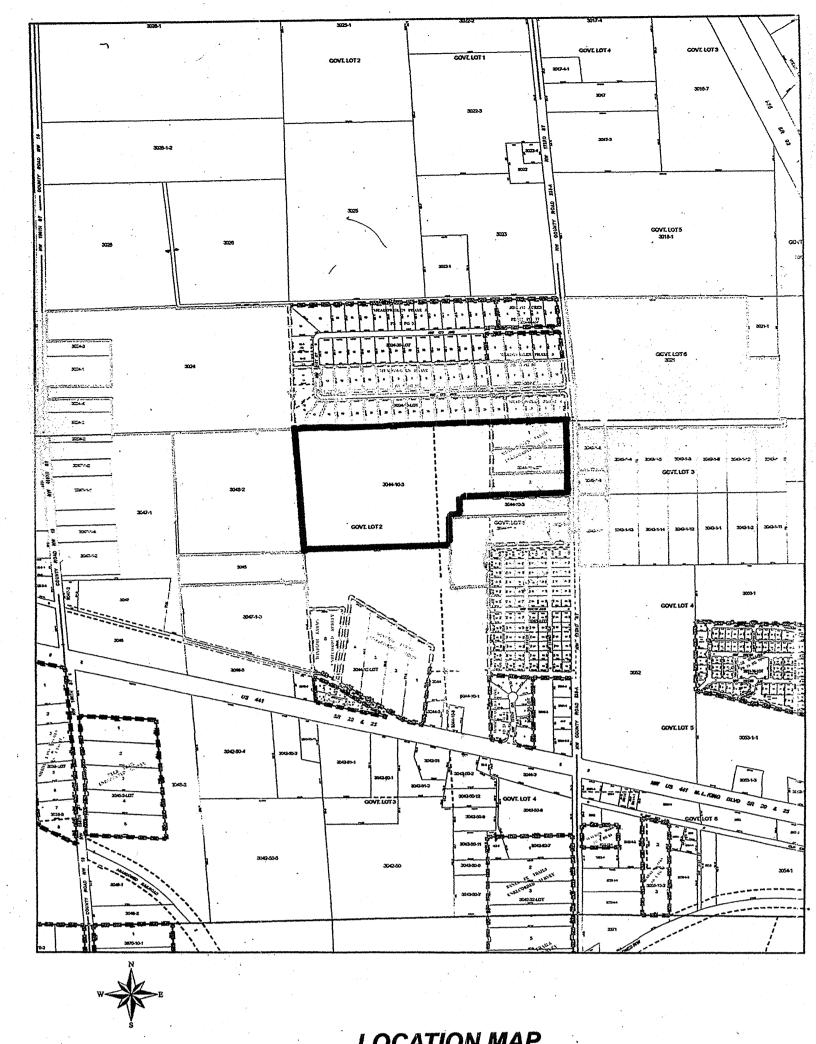
DEVELOPER
HARTLEY BROTHERS
1353 NW 53RD AVENUE
GAINESVILLE, FL 32669
(352)332-2112

SURVEYOR

GEOLINE SURVEYING 13430 NW 104TH TERRACE - SUITE 4 ALACHUA, FLA. 32615 (386) 462 - 0500 NO CHAMPION, HERITAGE, OR REGULATED TREES EXIST ON SITE OR ARE TO BE REMOVED AS PART OF THIS PLAT AND THEREFORE A TREE LOCATION SURVEY IN ACCORDANCE WITH SECTION 6.2.1(G) IS NOT REQUIRED

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	SHT. NO. 12	BY PASS LANE
	SHT. NO. 13	LEGAL PHASE 2
	PRELIMINARY	PLAT PHASE 1 - GEOLINE SURVEYORS



LOCATION MA

BUILDINGS TO BE SPRINKELED UNTIL SUCH TIME
THAT SUFFICIENT WATER IS AVAILABLE TO MEET CURRENT
STANDARDS FOR A CITY OWNED FIRE SYSTEM, FIRE HYDRANTS AND A
LINE OF SUFFICIENT SIZE IS TO BE INSTALLED IN PHASE 1 AND 2.

UTILITIES NOTES

1.) ELECTRIC SERVICE BY CLAY ELECTRIC - SERVICE TO BE OUTSIDE R/W IN 10 FT P.U.E.
2.) CENTRAL WATER SERVICE PROVIDED BY CITY OF ALACHUA, ON SITE CONSTRUCTION
BY DEVELOPER
3.) CENTRAL SEWER CONNECTION TO CITY OF ALACHUA, LIFT STATION, FORCE MAIN
EXTENSION AND ON SITE SEWER BY DEVELOPER

26.23 AC PHASE 1 AREA PHASE 1 RETENTION 4.65 AC 30.88 AC PHASE 1 TOTAL AREA 42.23 AC PHASE 2 AREA 8.03 AC PHASE 2 RETENTION PHASE 2 TOTAL AREA 50.26 AC PHASE 1 & 2 AREA 81.14 AC 75 UNITS PHASE 1 UNITS 2.43 U/AC PHASE 1 DENSITY 135 UNITS PHASE 2 UNITS PHASE 2 DENSITY 2.69 U/AC 210 UNITS TOTAL UNITS 2.59 U/AC TOTAL DENSITY SETBACKS 20 FT 15 FT 10 FT INT. SIDE 15 FT

JAMES J. MEEHAN, P.E.

1221 SW 96th STREET GAINESVILLE, FLORIDA 32607 Ph. (352) 215-2548 Fx. (352) 332-0431

			1.11. (002)	2 10	20101	(OC	2) 332 3
REV.			DESCRIPTION	· · · · · · · · · · · · · · · · · · ·		BY	DATE
T	LOT 51	七巨			· ·		7/12/15
					·		
				•		*.	
JOB	NAME:	BENTON H	u i s		DRAWN BY:	SPL	CHECKED BY: JM
					SCALE:		
LOC	ATION:	XXXX SW ALACHUA,	X th STREET		DATE:		7/1/15
		, (B (0) 10, (SHEET
DES	CRIPTION:	Conceptua	Site Plan			-	1

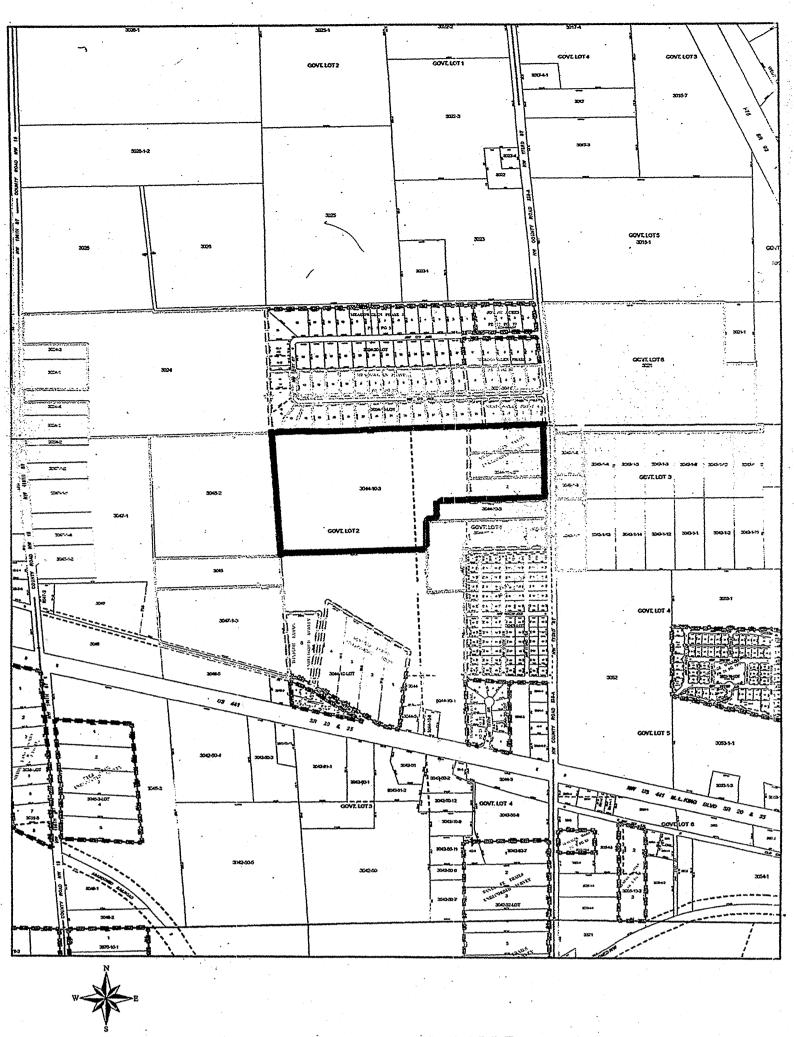
NOT FOR FINAL RECORDING

PHASE 1 & 2

BENTON HILLS



LOCATION MAP





LOCATION MAP

JAMES J. MEEHAN, P.E.


1221 SW 96th STREET
GAINESVILLE, FLORIDA 32607
Ph. (352) 215-2548 Fx. (352) 332-0431

REV.	DESCRIPTION	' •	BY	DATE
1 LOT:	51七户			7/12/15
IOD NAME		DRAWN BY:	SDI	CHECKED BY: JM
JOB NAME:	BENTON HILLS		JFL.	CHECKED BI. UM
LOCATION:		SCALE:		
LOCATION:	XXXX SW X th STREET ALACHUA, FLORIDA	DATE:		7/115
		~		SHEET
DESCRIPTION	Conceptual Site Plan			1A /

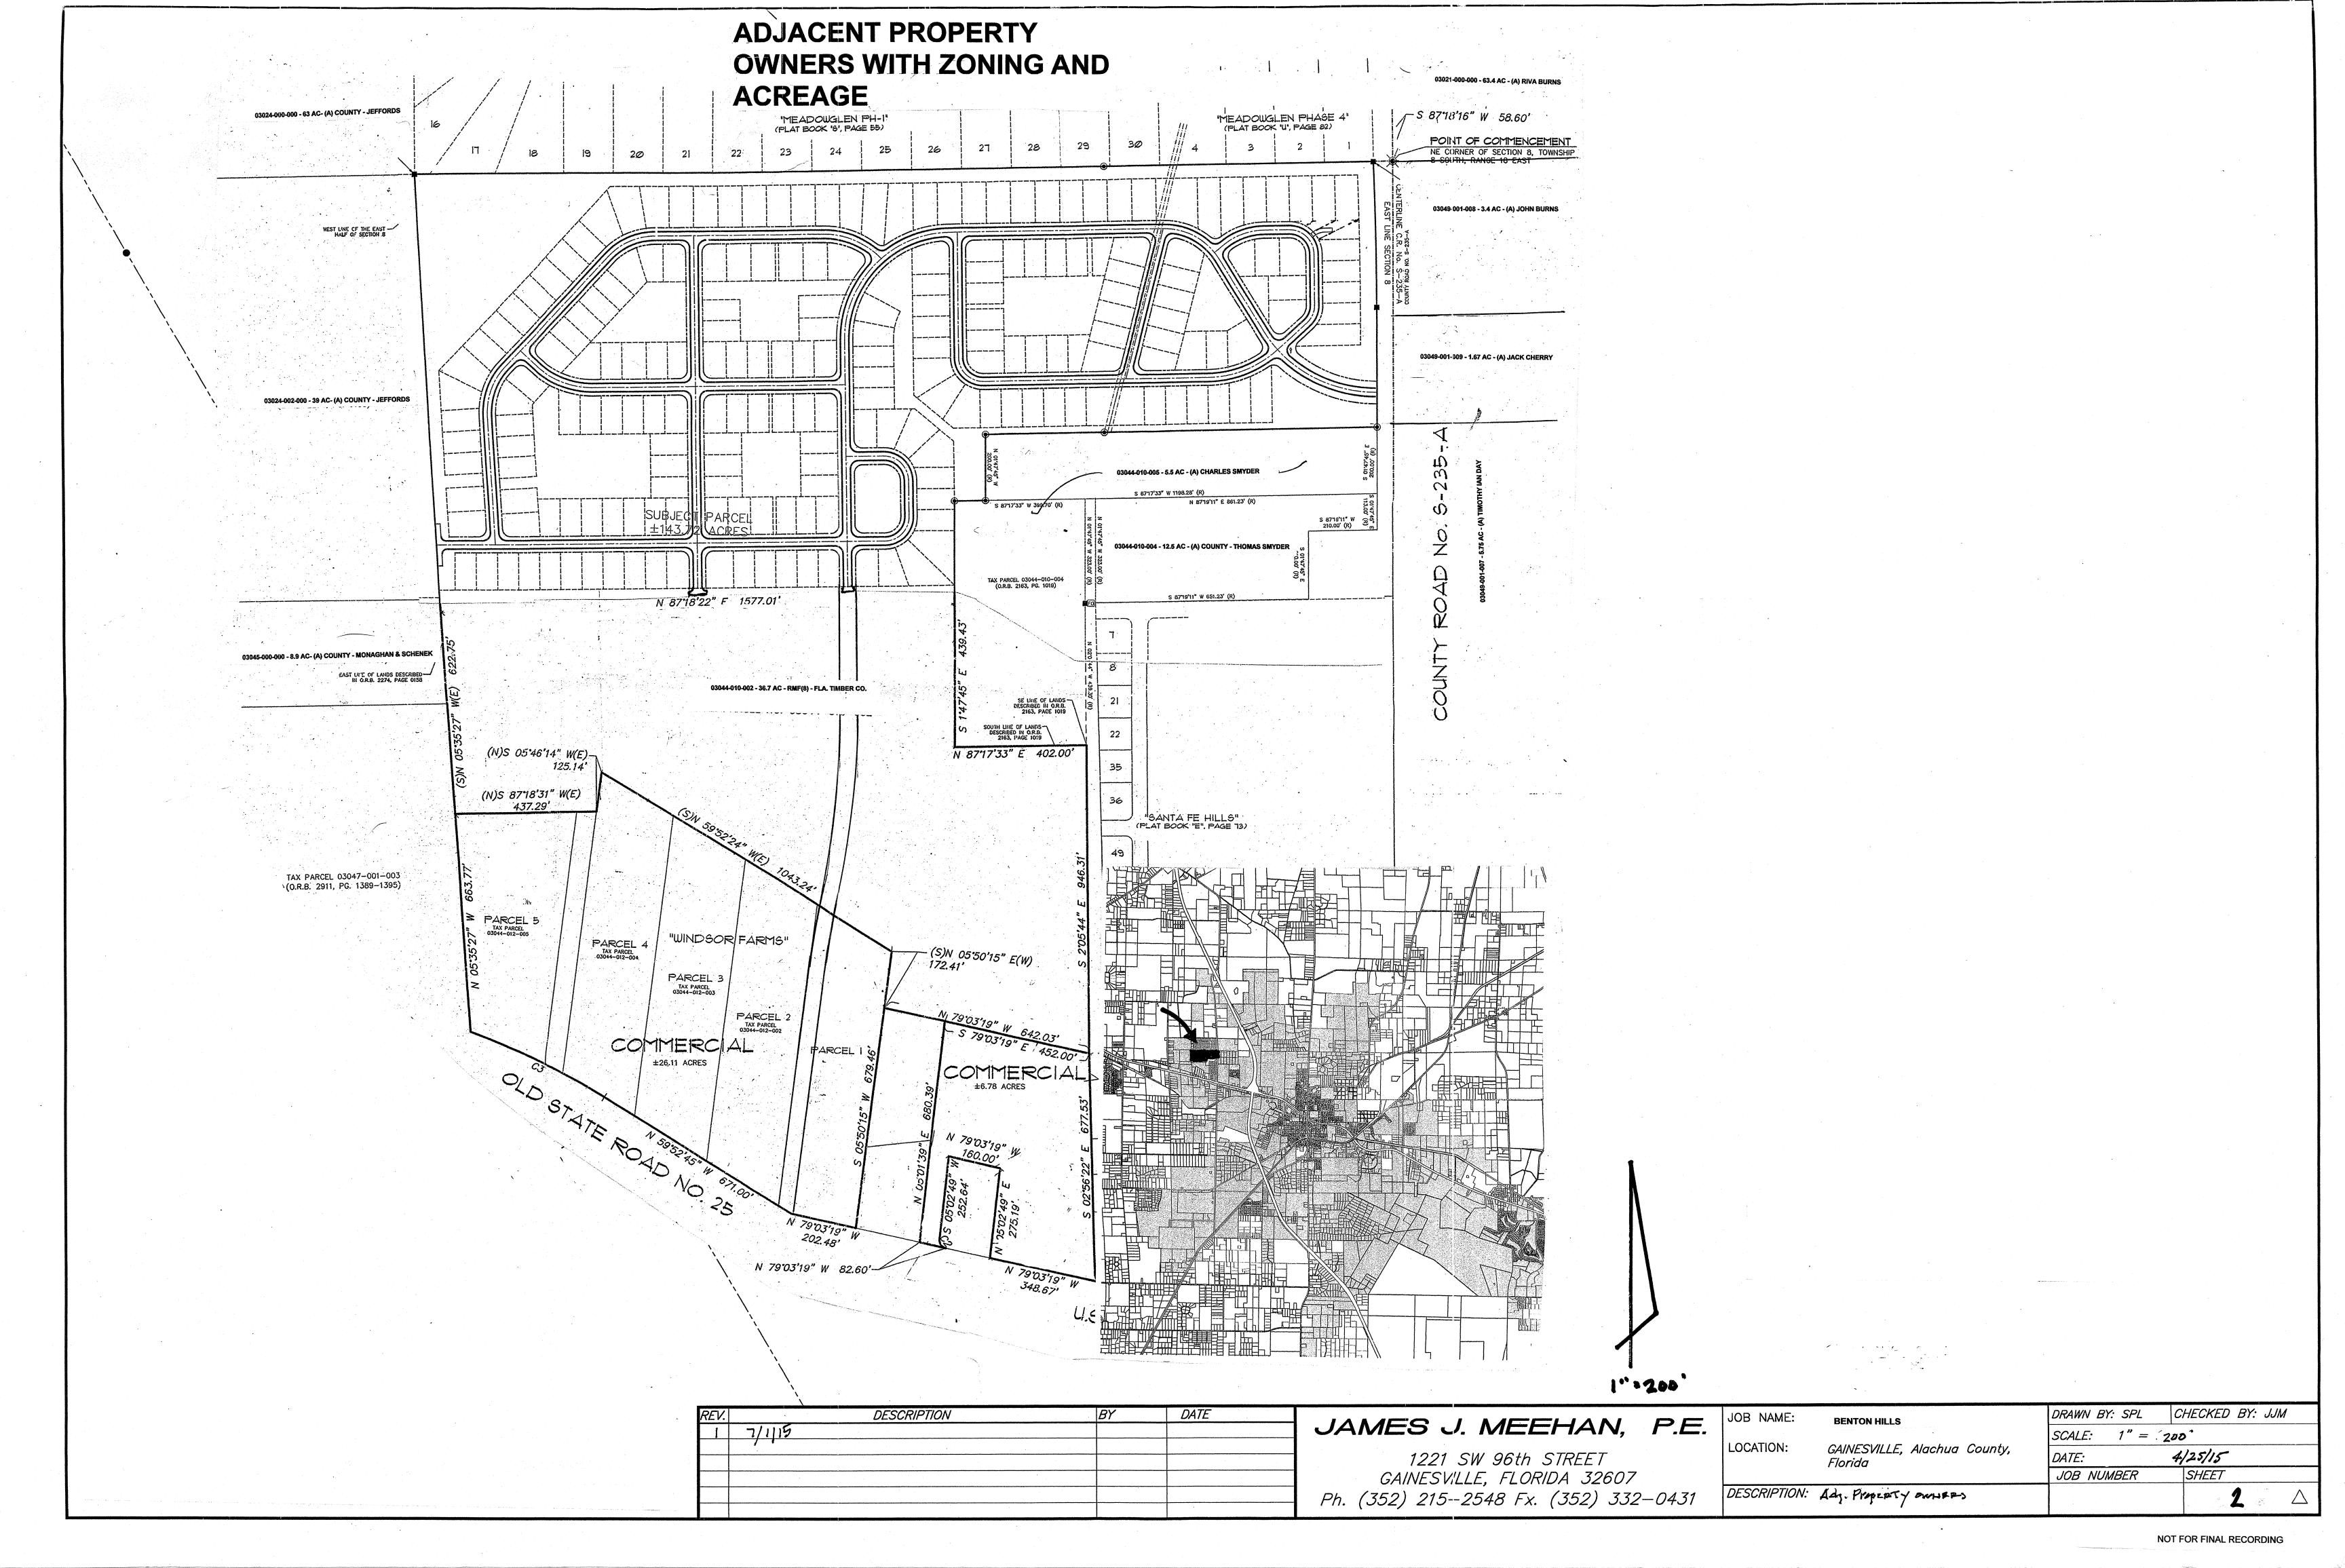

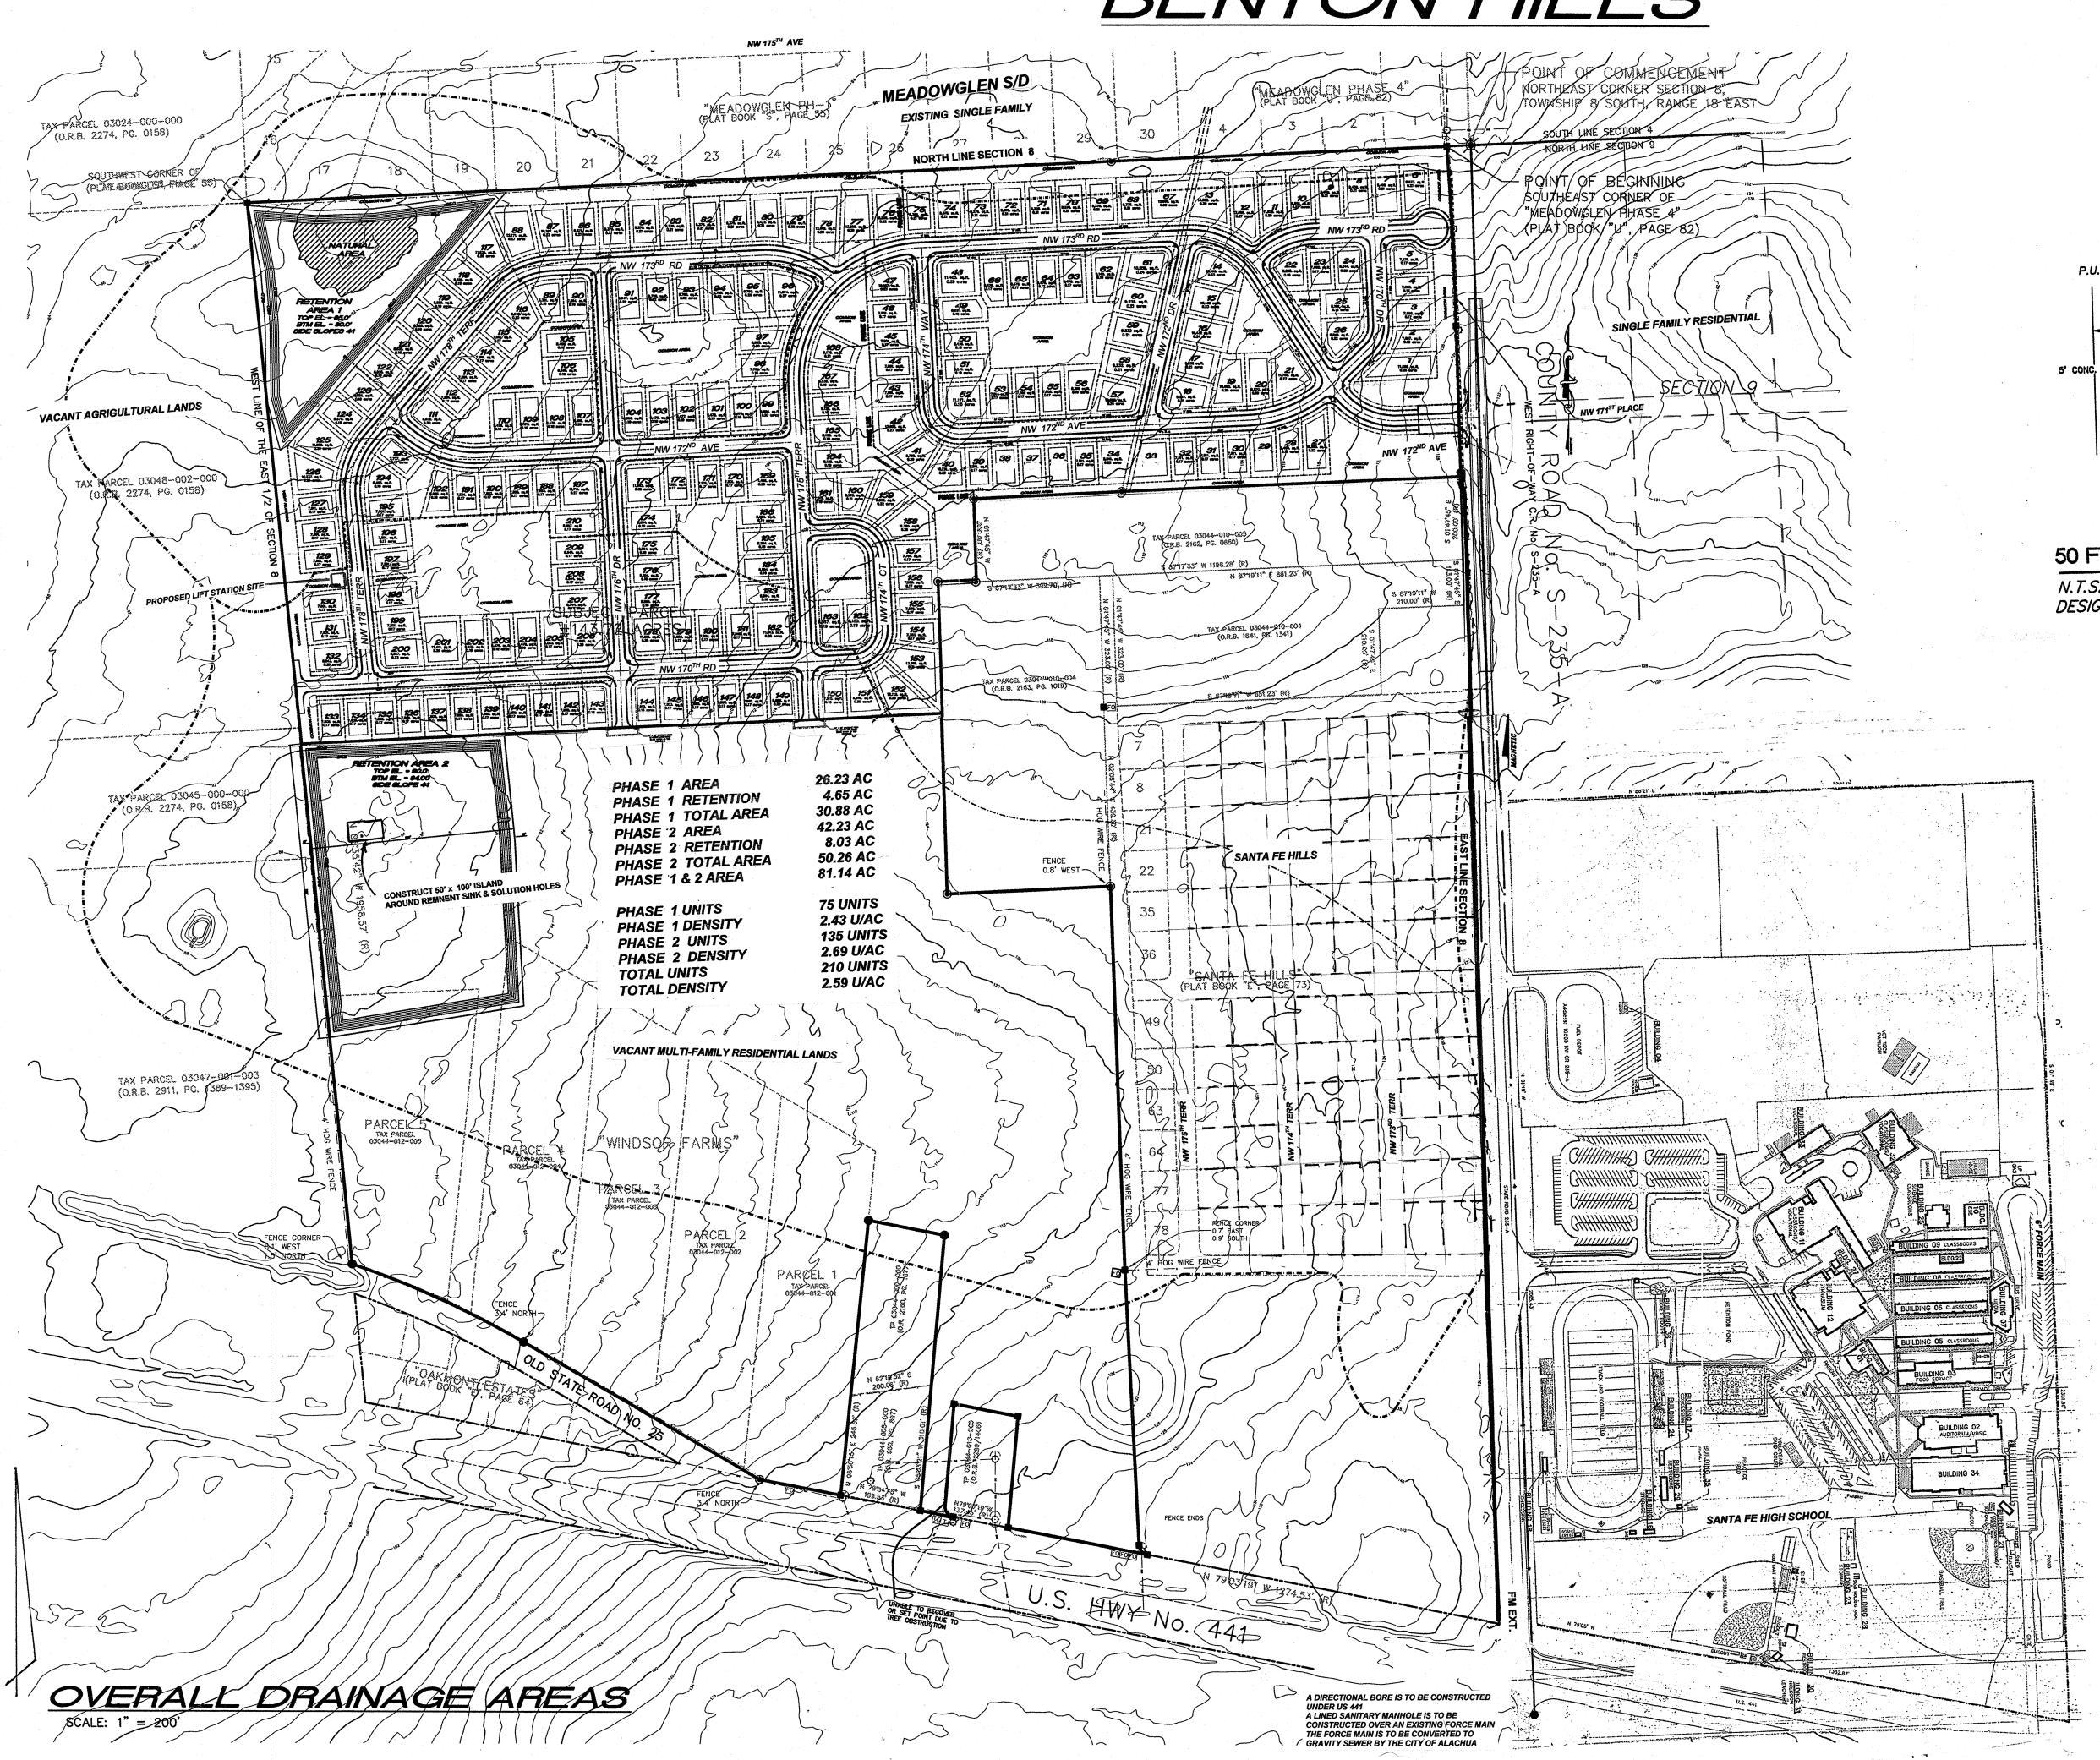

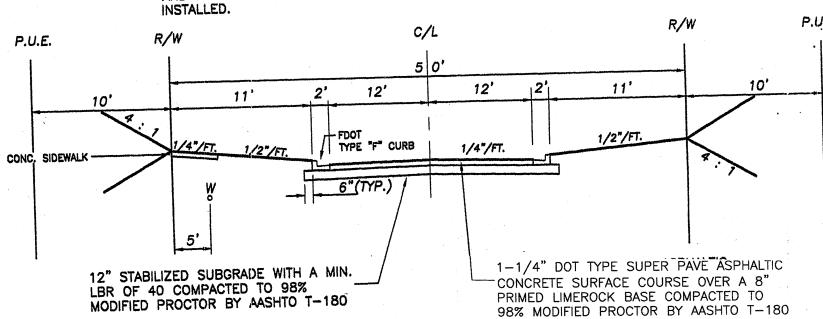NOTE: ALL AREAS WITHIN THE LIMITS OF CONSTRUCTION SHALL BE SEEDED AND MULCHED AFTER FINAL GRADING AND ALL UTILITIES HAVE BEEN



50 FT. RIGHT OF WAY MAIN ROAD CROSS-SECTION

N.T.S. DESIGN SPEED = 30 MPH

SANITARY SEWER:

Sanitary sewer shall be installed throughout Phase 1 of Benton Hills as well as all future phases. The sewer shall flow downhill to the west to a proposed lift station to be located at the common area south of the retention area. Gravity sanitary sewer shall be installed according to the approved standards and specifications of the City of Alachua, and shall be deeded to the City after the approved construction.

The proposed lift station is to be built as per the standards and specifications of the City of Alachua and likewise after construction and inspection shall be deeded to the City of Alachua.

A force main shall be constructed from the lift station to the City of Alachua central sewer system. All sewer construction shall be permitted with the State of Florida DEP.

WATER SYSTEM:

Water presently exists in CR 235-A. An 8" water main shall be installed with appropriate fire hydrant locations throughout phase 1 of Benton Hills. The water main shall be installed per the approved standards and specifications of the City of Alachua. After construction, inspection, and disinfection, the water main shall be deeded to the City of Alachua for operation and maintenance. Future phases of Benton Hills will require additional 8" water mains and will eventually require an extension to US 441 to loop the system. The water system shall be permitted with the State of Florida DEP.

DRAINAGE:

This site drains from east to west to an existing low along the west property line (refer to drainage divides provided). At this location Retention Area no. 1 is to be constructed. This retention area is to be sized to accommodate the 100yr critical storm event as required by the City of Alachua and the SRWMD. There will be no discharge from this basin. Water shall exit the basin thru percolation.

Retention Area no 1 shall be constructed along with Phase 1 of Benton Hills. Storm pipes shall be installed from Phase 1 to the Retention Area in the location and size along the future R/W. Additional retention will be required for future phases of Benton Hills.

NOTE: EXISTING SOLUTION HOLES AND REMNENT SINK HOLES IN RETENTION AREA NO. 2 SHALL HAVE AN ISLAND CONSTRUCTED AROUND THAT PARTICULAR AREA AS INDICATED ON THIS SHEET

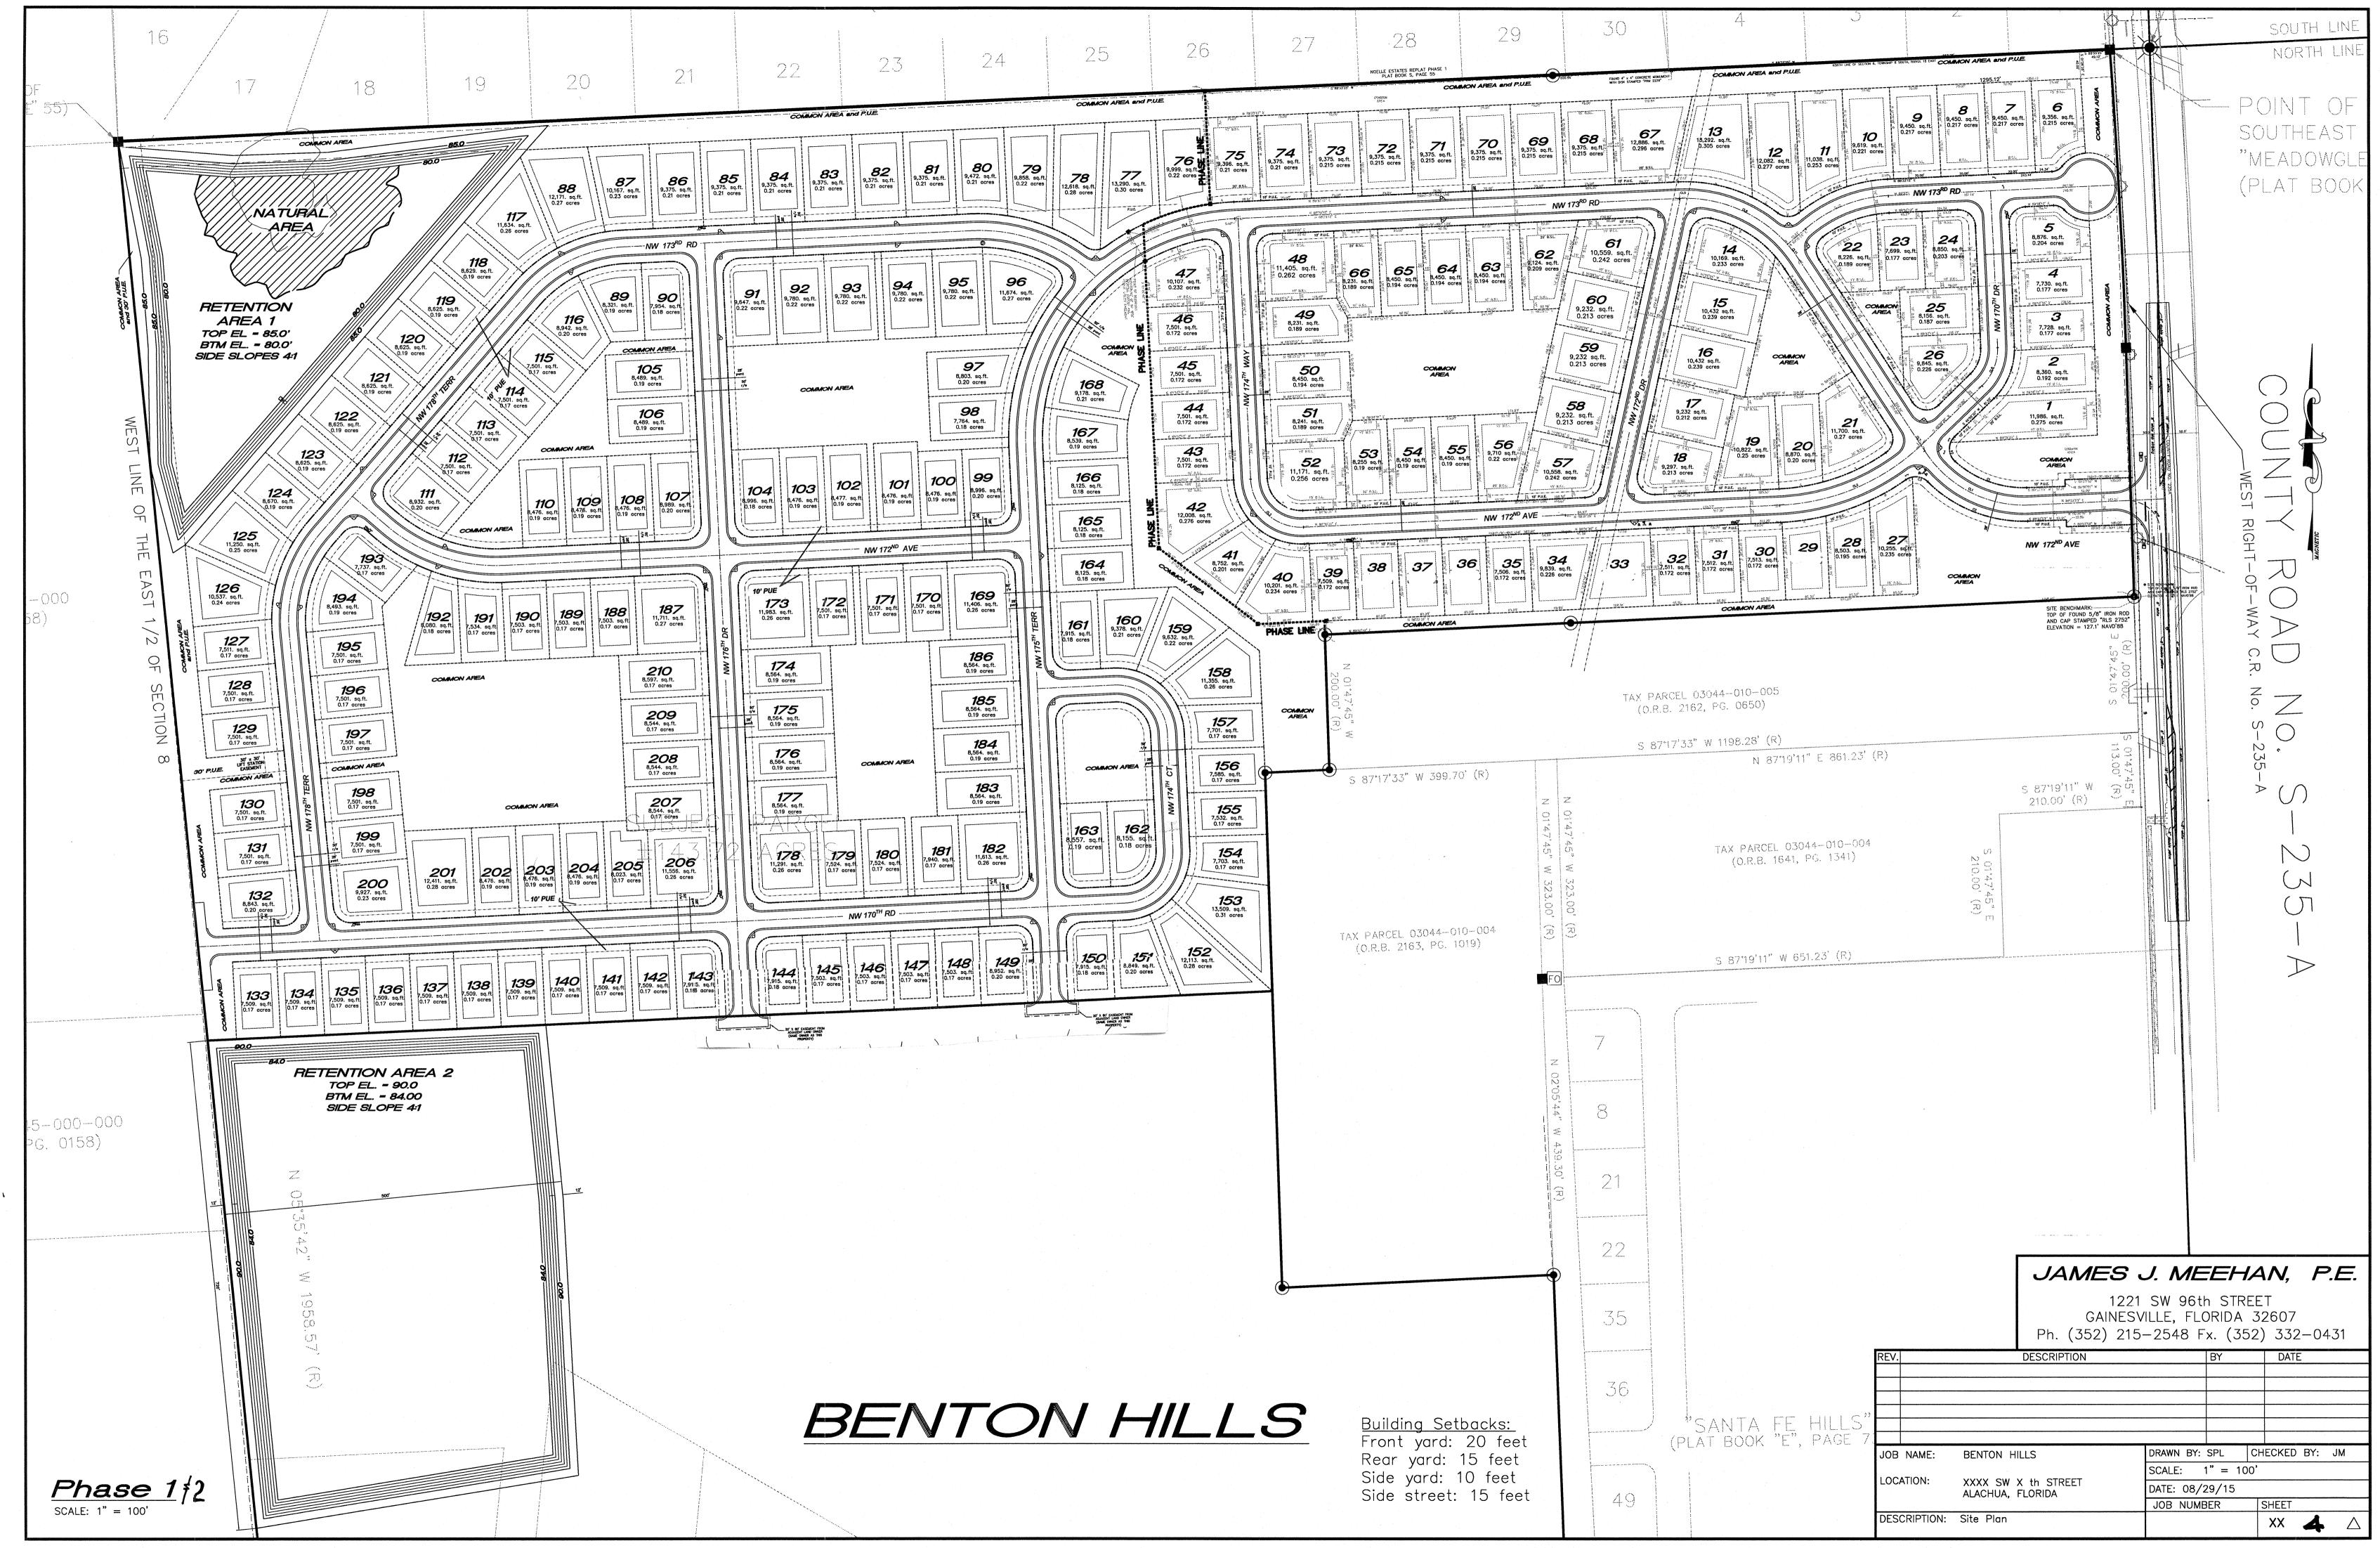
LEFT TURN BY-PASS CR 235-A

Plans for the left turn by-pass have been submitted to Alachua County Public Works for review


JAMES J. MEEHAN, P.E.


1221 SW 96th STREET
GAINESVILLE, FLORIDA 32607
Ph. (352) 215-2548 Fx. (352) 332-0431


DESCRIPTION 1 7/1/15 2 9/1/15 - Sens Connection & Refer from DRAWN BY: SPL CHECKED BY: JM BENTON HILLS JOB NAME: SCALE: 1" = 200'LOCATION: XXXX SW X th STREET DATE: 03/24/2015 ALACHUA, FLORIDA JOB NUMBER SHEET DESCRIPTION: OVERALL DRAINAGE AREAS 3 OFFSITE SEWER



BENTON HILLS PHASE I NORTH LINE OF SECTION 8, TOWNSHIP 8 SOUTH, RANGE 18 EAST COMMON AREA and P.U.E. NOELLE ESTATES REPLAT PHASE 1 PLAT BOOK S, PAGE 55 COMMON AREA and P.U.E. FOUND 4" x 4" CONCRETE MONUMENT-WITH DISK STAMPED "PRM 2228" AREA and P.U.E. 9,450. sq.ft. 0.217 acres **67** 12,886. sq.ft. 0.296 acres 0.217 acres 13,292. sq.ft. 0.305 acres 9,619. sq.ft 12,082. sq.ft. 0.277 acres 13,290. sq.ft 0.30 acres 0.204 acres 10,559. sq.ft 62 0.242 acres 9,124. sq.ft. 0.209 acres/ 11,405. sq.ft 8,231. sq.ft 10,107. sq.ft. 0.232 acres 0.177 acres 60 COMMON 10,432 sq.ft 0.213 acres 8,156. sq.ft. 0.239 acres 0.187 acres 8,231. sq.ft. 7,728. sq.ft. 7,501. sq.ft. 0.177 acres 0.172 acres 26 AREA COMMON 9,232 sq.ft. 10,432 sq.ft. 9,845. sq.ft. 0.213 acres 0.239 acres COMMON 8,360. sq.ft 7,501. sq.ft. 0.192 acres 8,450. sq.ft. 0.172 acres *58* 9,232 sq.ft. 0.212 acres 51 9,232. sq.ft. 11,986. sq.ft. 7,501. sq.ft. **21**11,700. sq.ft. 0.27 acres 0.275 acres 8,241. sq.ft. 0.213 acres 0.172 acres 0.189 acres Λ / _____ N 8898'35" ξ _____ \$ 217.26" _____. S 88'33'12" W 115.40' N 88'33'12" E 115.40" ---**56** 9,710 sq.ft. **20** 8,870. sq.ft. 0.20 acres **55** 8,450. sq.ft. 0.19 acres ₫10,822. sq.ft 0.25 acres 0.22 acres COMMON 57 7,501. sq.ft. AREA 9,297. sq.ft. 0.172 acres STOP SIGN 0.19 acres 10 10,558. sq.ft. 11,171. sq.ft. 0.213 acres 0.242 acres 0.256 acres 24" STOP BAR & STOP SIGN NOTE: ALL PVMT MARKINGS WITHIN CR 235-A TO BE THERMOPLASTIC 12,008. sq.ft. 0.276 acres 10' P.U.E. 275 10,255. squart. 0.235 acres 8,752. sq.ft. 0.201 acres 10,715. sq.ft. 10, 0.17 acresi COMMON 0.246 acres AREA 10,201. sq.ft. 106.89 0.234 acres COMMON AREA SITE BENCHMARK: TOP OF FOUND 5/8" IRON ROD AND CAP STAMPED "RLS 2752" NOTE: ALL ROAD & STREET SIGNS TO MEET USDOT UNIFORM TRAFFIC CONTROL DEVICE 160 9,378. sq.ft. %/ 0.21 acres COMMON AREA ELEVATION = 127.1' NAVD'88 159 9,632. sq.ft. 0.22 acres PHASE LINE DESCRIPTION DRAWN BY: SPL CHECKED BY: JM JAMES J. MEEHAN, P.E. <u>Building Setbacks:</u> Front yard: 20 feet Rear yard: 15 feet SCALE: 1" = 50'XXXX SW X th STREET ALACHUA, FLORIDA Phase 1 1221 SW 96th STREET DATE: 08/29/15 Side yard: 10 feet GAINESVILLE, FLORIDA 32607 JOB NUMBER SHEET SCALE: 1" = 50'Side street: 15 feet DESCRIPTION: Site Plan XX 5 Ph. (352) 215-2548 Fx. (352) 332-0431

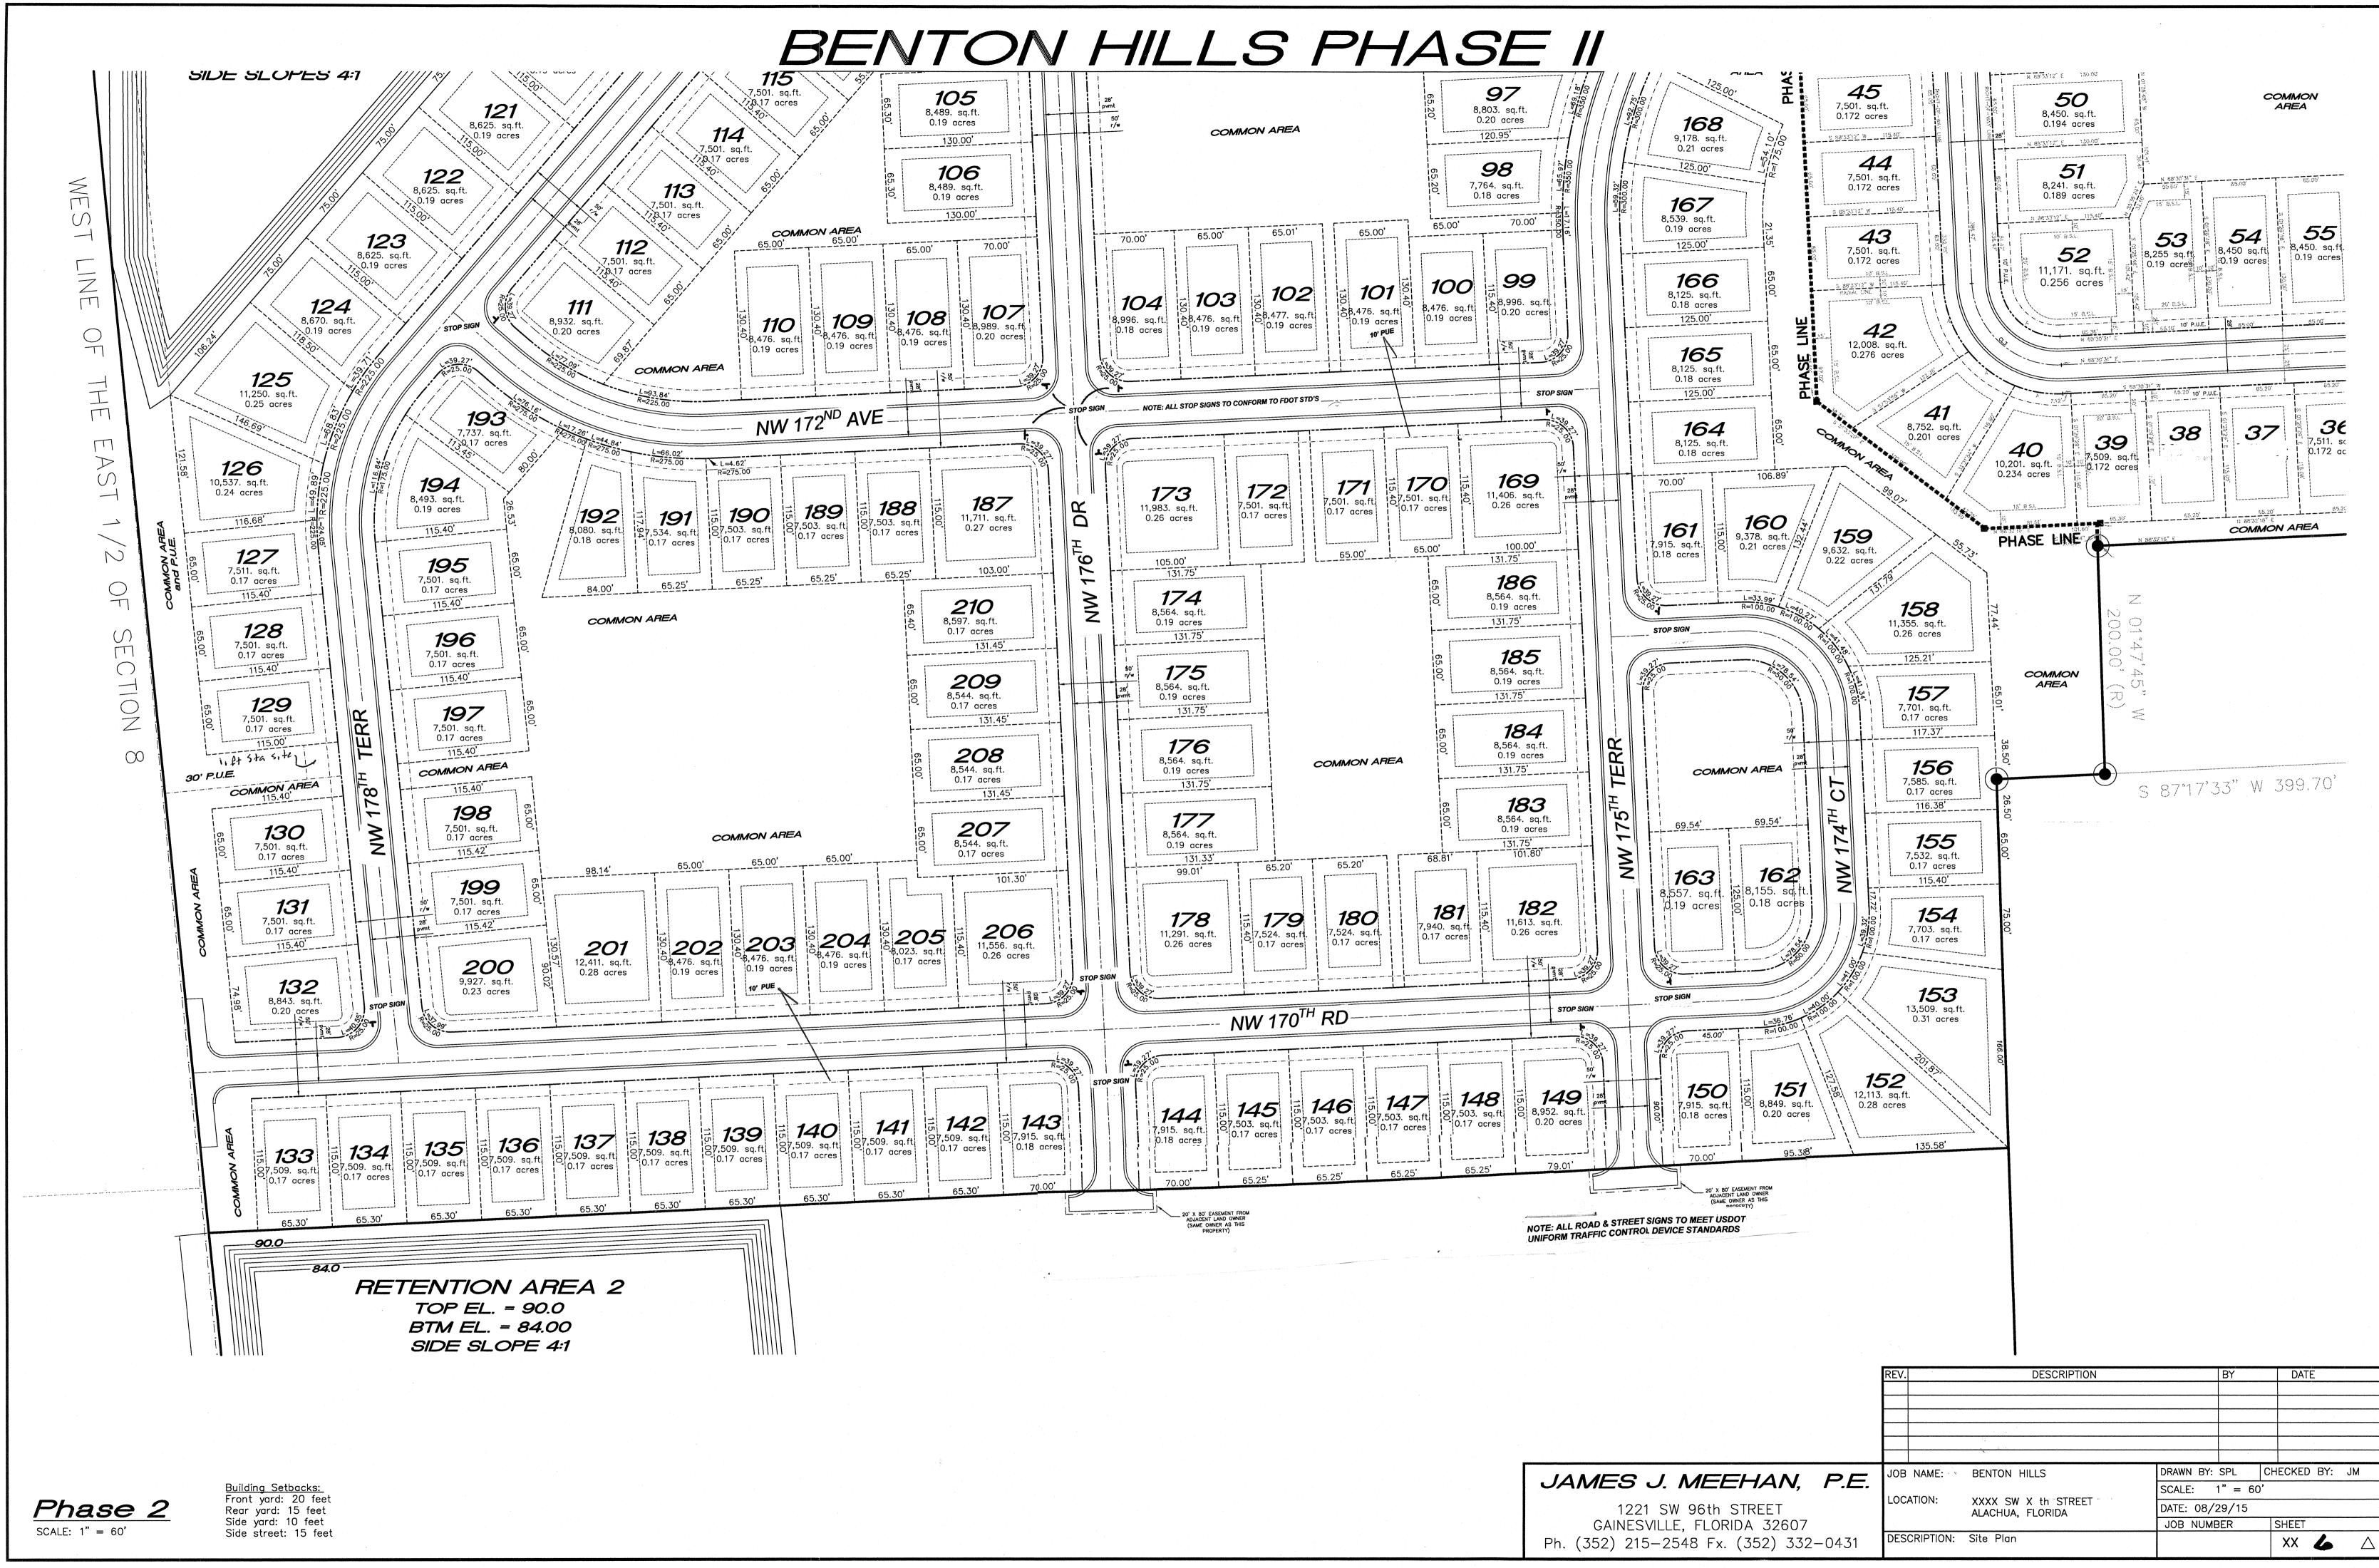

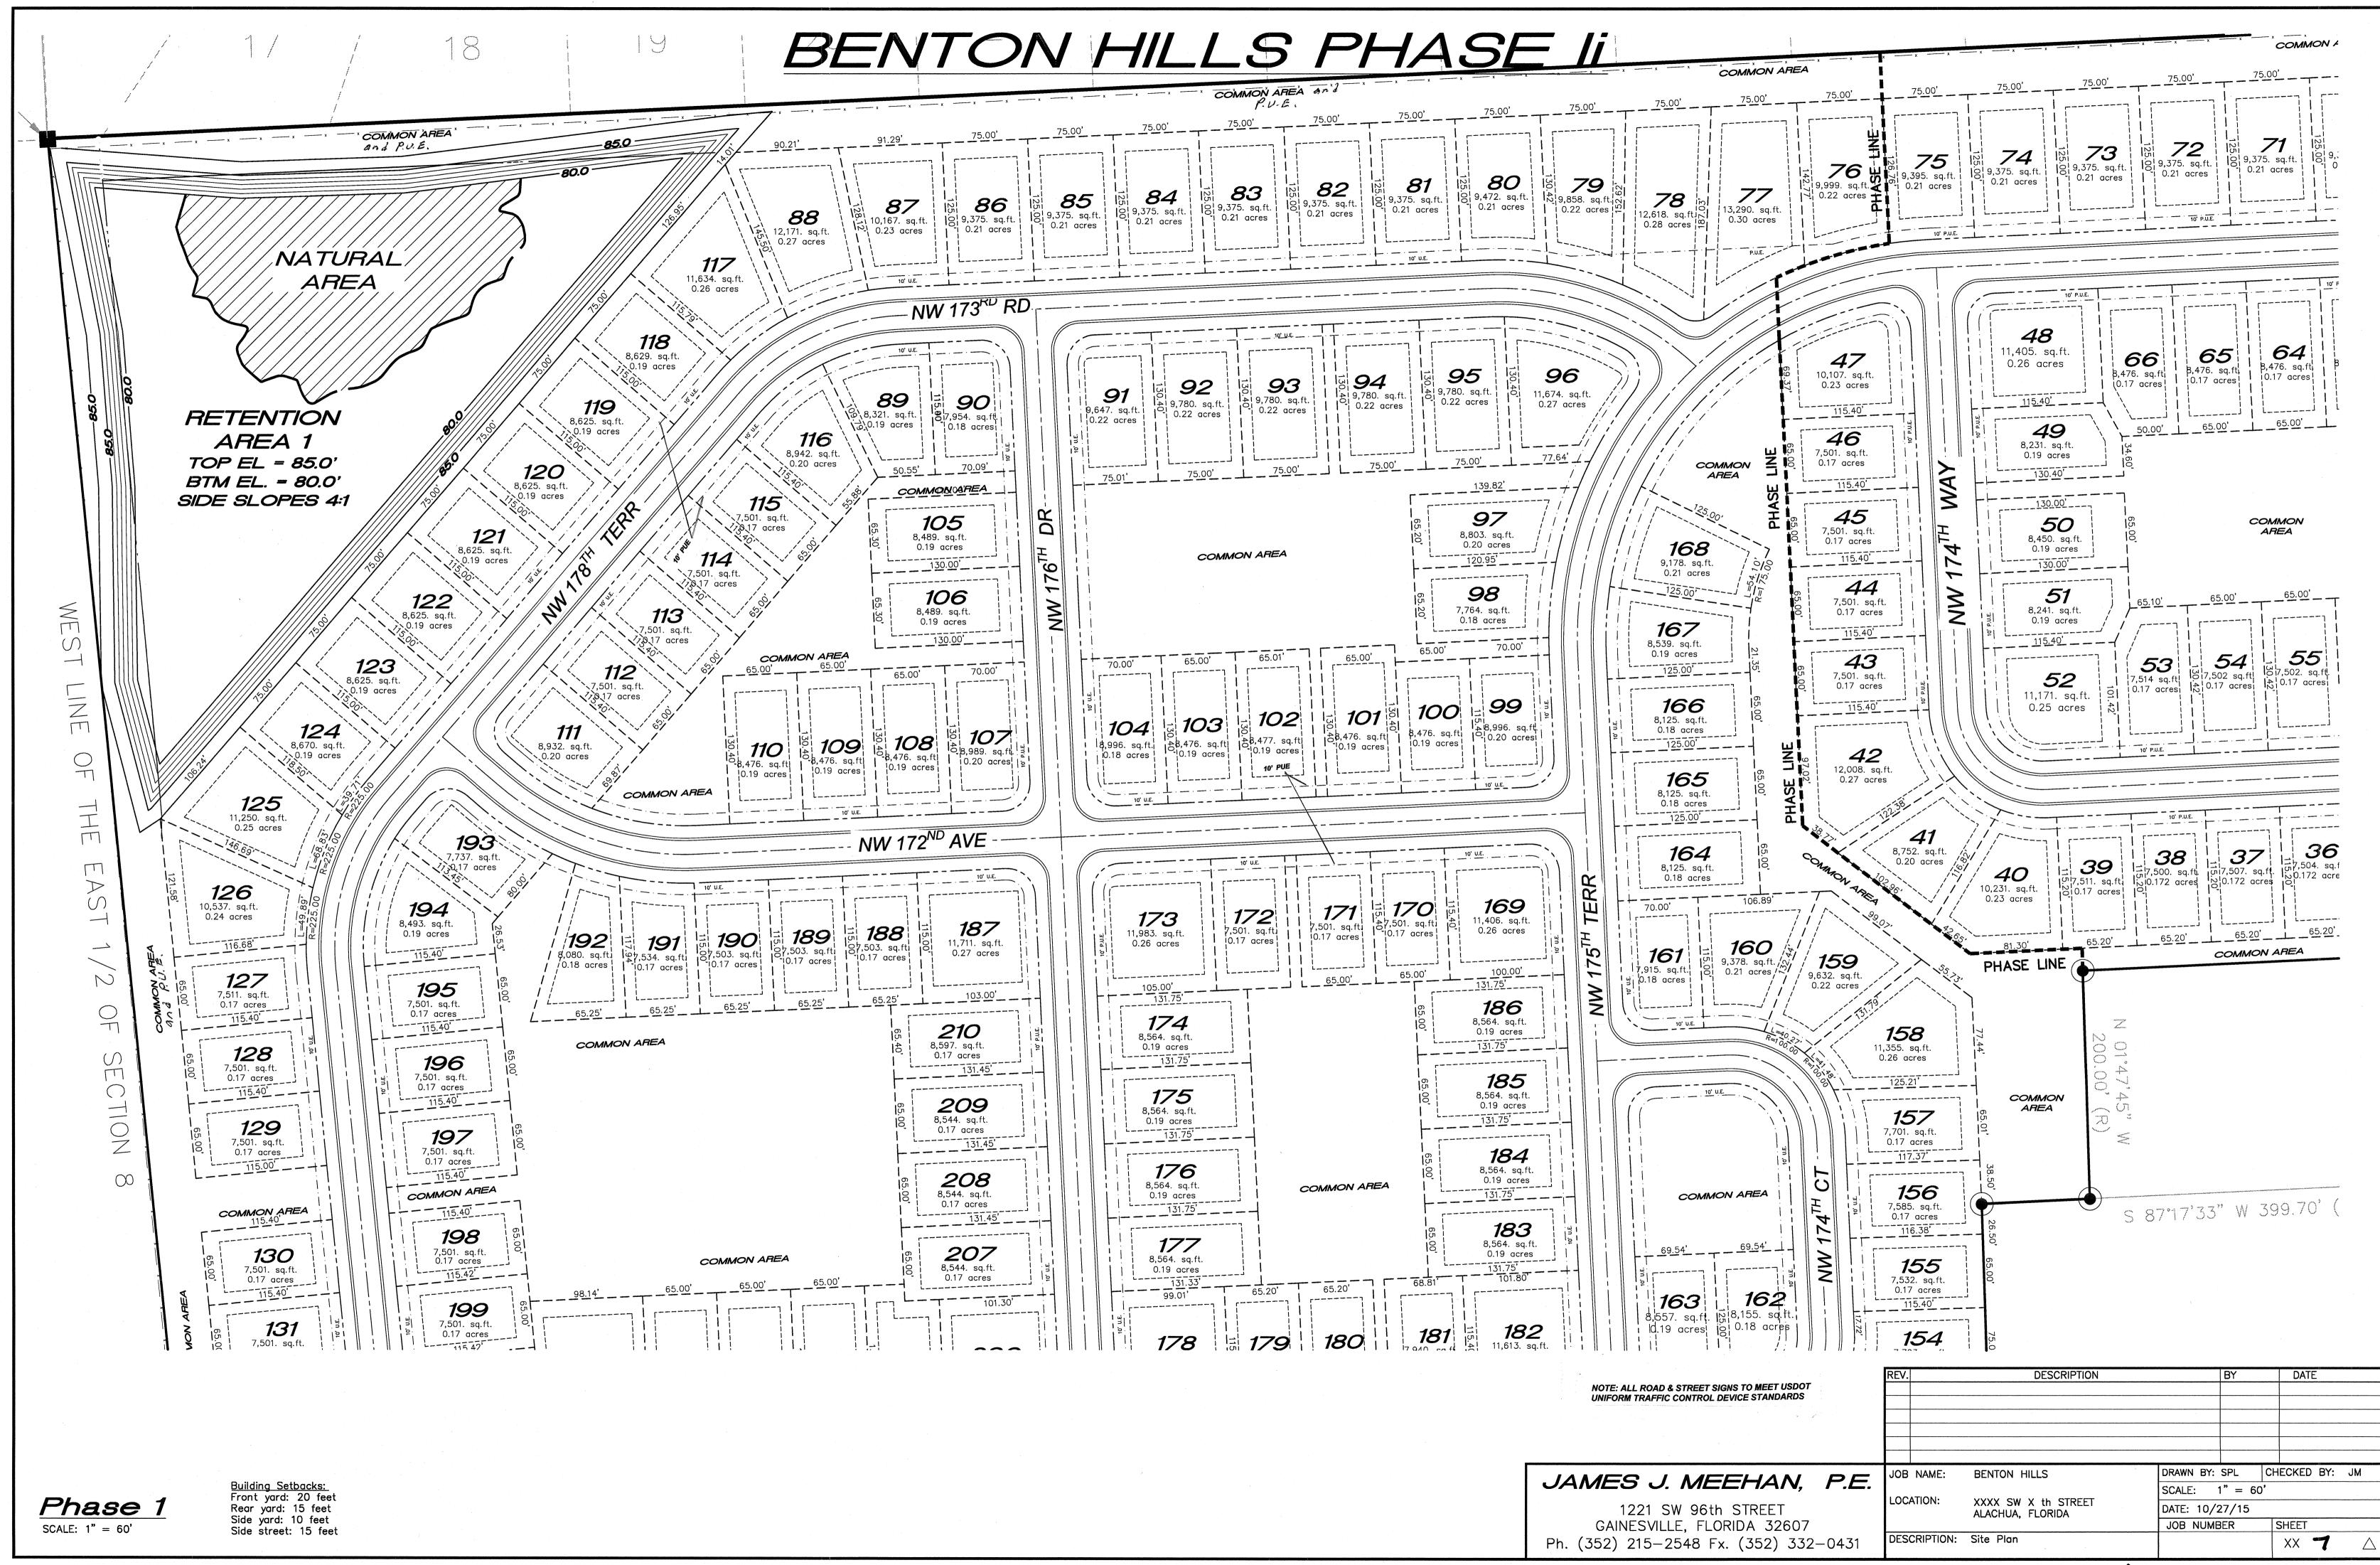


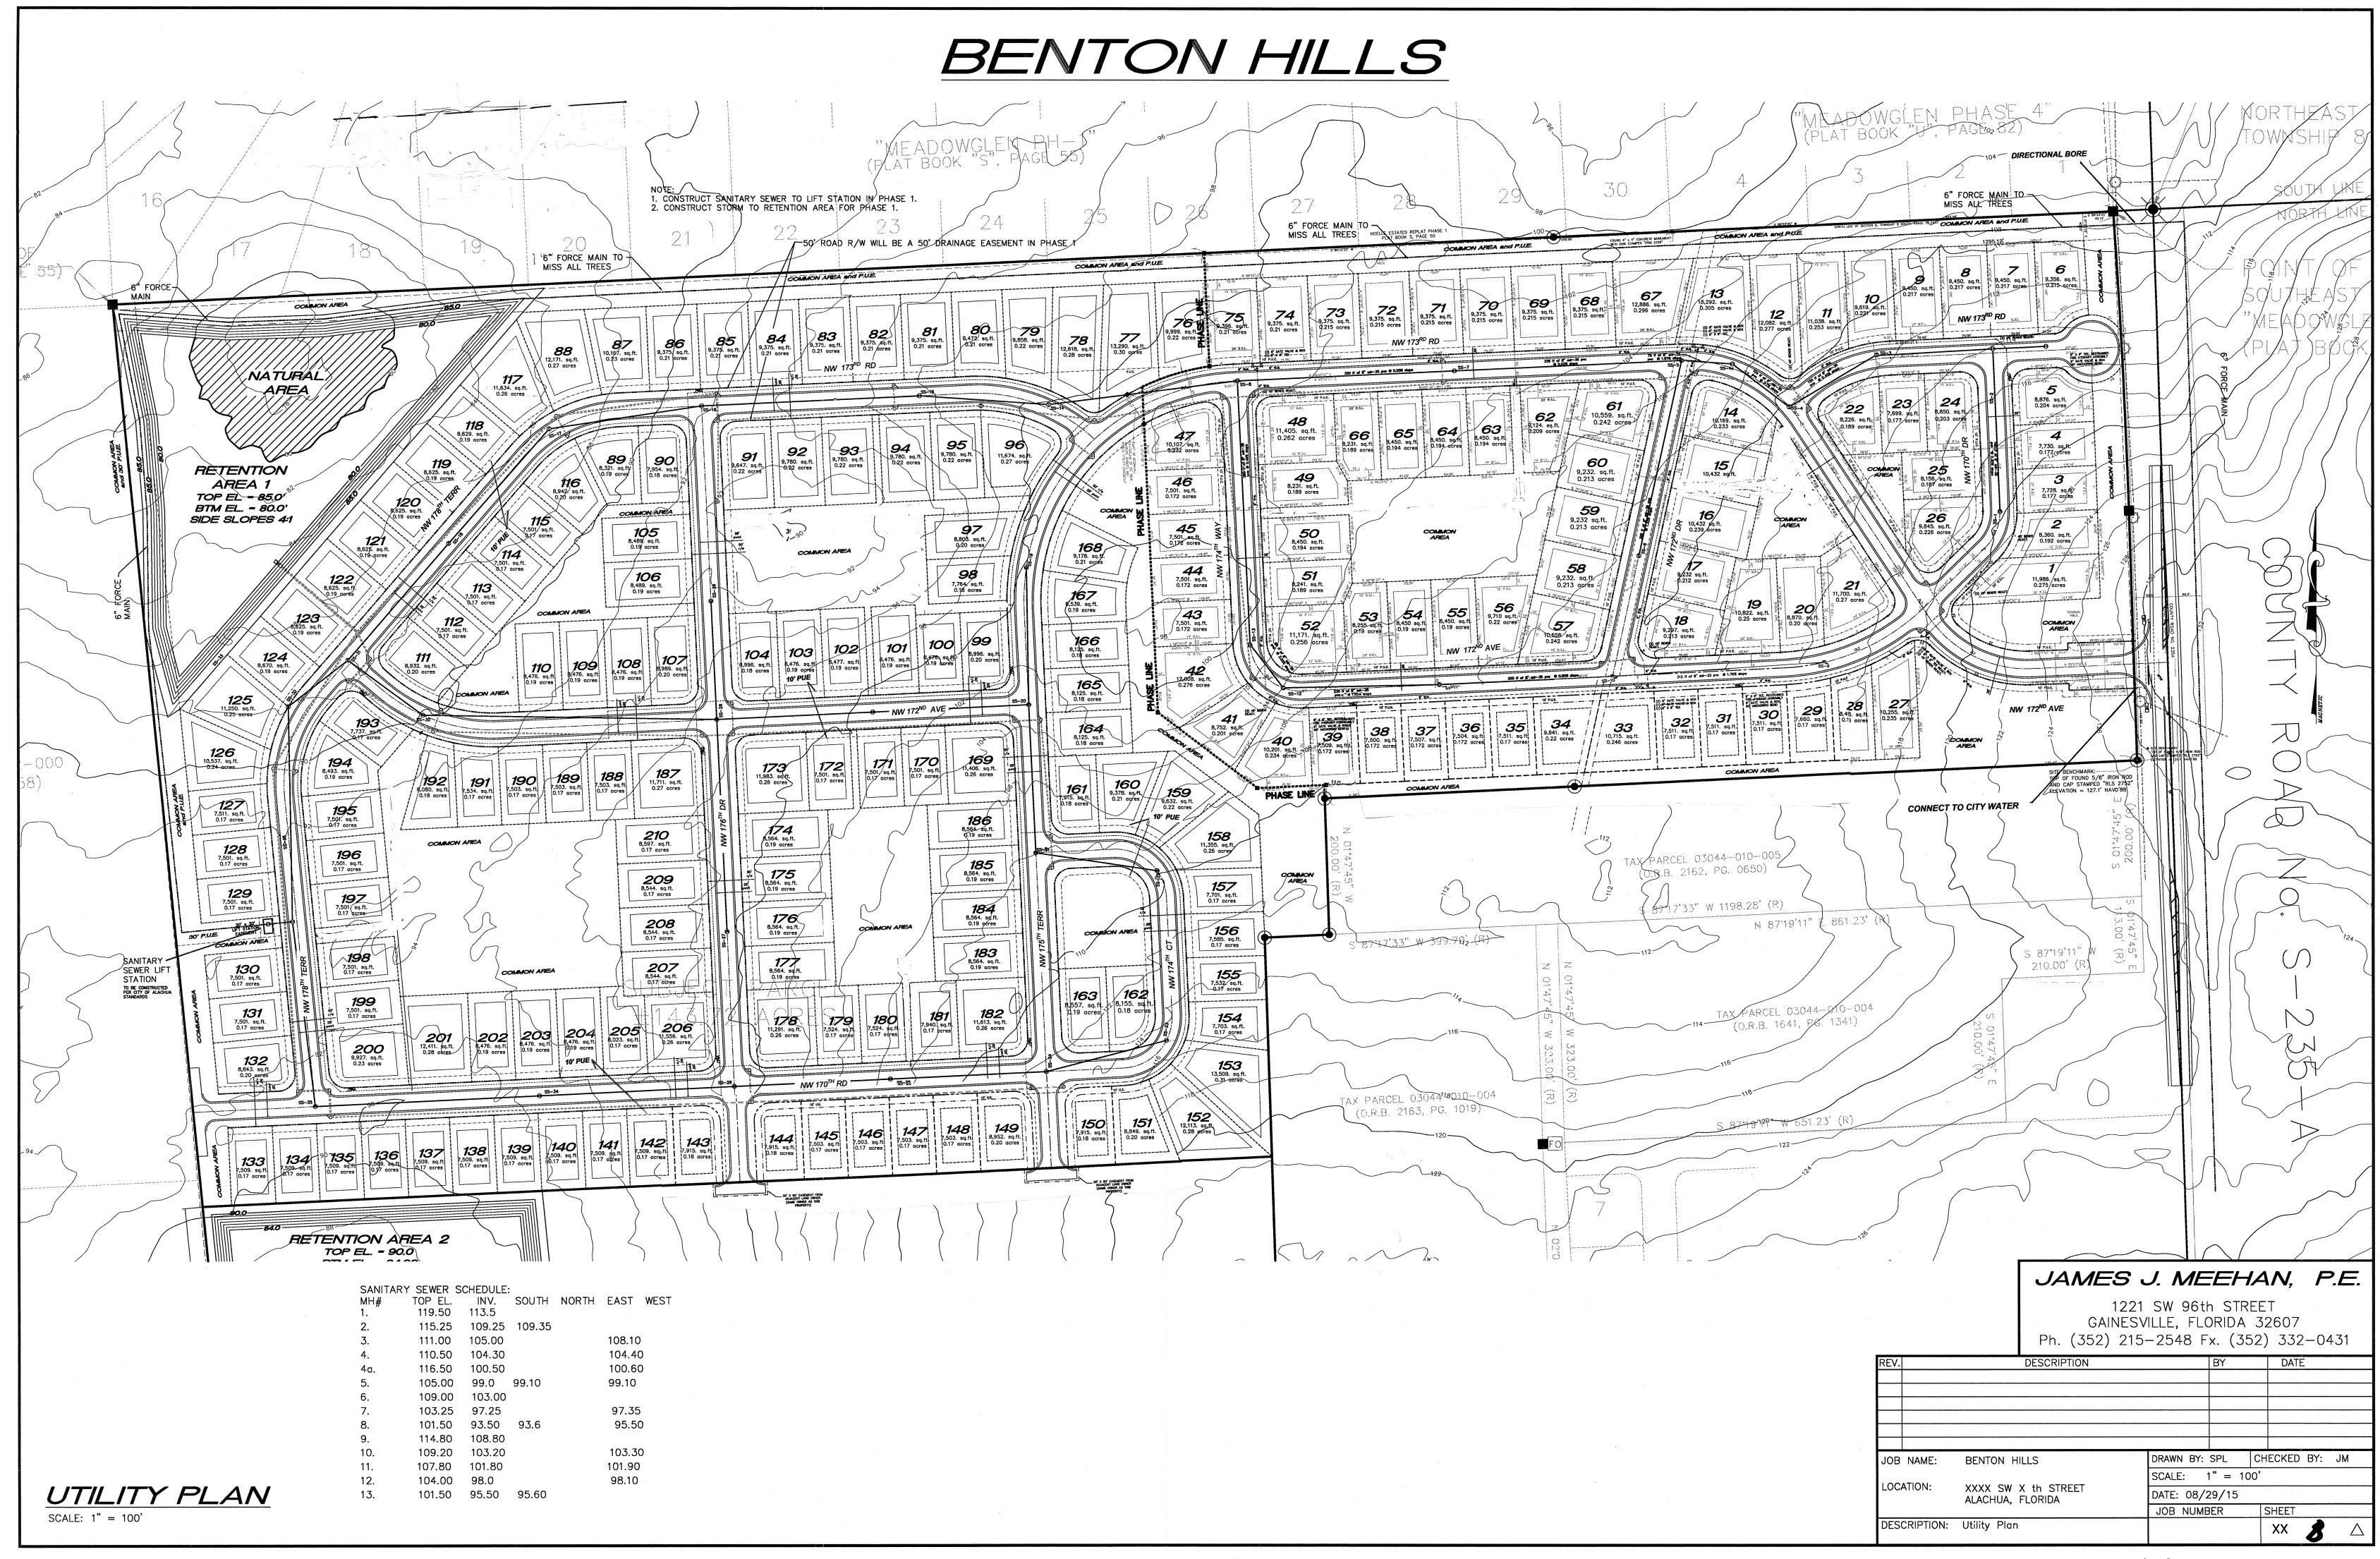

BENTON HILLS PH 1 6" FORCE MAIN TO FOUND 4" x 4" CONCRETE MONUMENT... MON AREA and P.U.E. 6 9,356. sq.f 9,450. sq.ft. 13,292. sq.ft. 0.305 acres NW 173RD RD 0.215 acres 13,290. sq.ft 0.30 acres 8 X 8" TEE, RESTRAINED FIRE HYDRANT ASSEMBLY 6" GATE VALVE & BOX 90" ANCHORING BEND 8,876. sq.ft. 61 0.204 acres 10,559. sq.ft 62 9,124. sq.ft. 0.209 acres 11,405. sq.ft 15 9,232. sq.ft 10,432 sq.ft. 0.213 acres 8,156./sq.ft. 0.239 agres 0.187 acres **3** 8,231. sq.ft. 0.189 acres 0.172 acres COMMON 10,432 sq.ft 0.239 acres **50** 8,450. sq.ft. 0.194 acres 8,360. sq.ft. 0.192 acres/ 7,501. sq.ft. 0.172 acres 58 58 9,232 sq.ft. 51 9,232. sq.ft 11,986./sq.ft. 7,501. sq.ft. 0.212 acres 0.213 acres **\$,241.** sq.ft. 0.275/acres 0.172 acres 0.189 acres 1,700. sq.ft. 0.27 acres **56** 9,710 sq.ft. **20** 8,870. sq.ft. 0.20 ocres 10,822. sq.ft 0.25 acres 0.22 acres COMMON 7,501. sq.ft. 0.19 acres AREA 0.172 acres 0.19 acres 0.19 acres 11,171. /sq.ft. 10,558. sq.ft. 0.242 acres sq.ft. cres 312 If of 8" sdr-35 pvc @ 1.76% slope sq.ft. (2) 8" GATE VALVE & BOX (1) 16"—GATE VALVE & BOX (1) 18" X 6" TEE acres **27** 10,255. sq. ft. 28 7, 8,503. sq.ft. 29 17,660. sq.ft. 15, 0.17 acres 0.235 acres CONNECT TO CITY WATER 8,752. sq.ft. 0.201 acres 54 COMMON acres JAMES J. MEEHAN, P.E. SANITARY SEWER SCHEDULE: 1221 SW 96th STREET TOP EL. INV. SOUTH NORTH EAST WEST GAINESVILLE, FLORIDA 32607 119.50 113.5 115.25 Ph. (352) 215-2548 Fx. (352) 332-0431 DESCRIPTION 110.50 104.40 109.00 103.25 97.35 114.80 DRAWN BY: SPL | CHECKED BY: JM JOB NAME: BENTON HILLS 103.30 101.90 SCALE: 1" = 50'107.80 XXXX SW X th STREET ALACHUA, FLORIDA UTILITY PLAN 104.00 DATE: 08/29/15 101.50 95.50 95.60 JOB NUMBER SHEET SCALE: 1" = 50'DESCRIPTION: Utility Plan XX

BENTON HILLS PH 2 7-50' ROAD R/W WILL BE A 50' DRAINAGE EASEMENT IN PHASE 1 COMMON AREA and P.U.E. MISS ALL TREES COMMON AREA and P.U.E. COMMON AREA 81 9,472. sq.ft 9,375. sq.ft 78 9,375. sq.ft. 0.21 acres 13,290. sq.ft 0.21 acres 0.22 acres 12,618. sq.ft. 0.30 agres 0.21 acres 0.28 acres 12,171. sq.ft. 0.27 acres NATURAL AREA 11,634. sq.ft. 0.26 acres 8,629. sq.ft. 95 9,780. sq.ft. 11,674. sq. 9,780. sq.ft. 0.27 acres RETENTION 0.19 acres 116 AREA 1 46 8,942/ sq.ft. 7,501. sq.ft. TOP EL = 85.0' 0.172 acres BTM EL. = 80.0' COMMON AREA SIDE SLOPES 4:1 105 7,501. sq.ft. 8,489. sq.ft. 168 0.19/ acres COMMON AREA S 88'33'12" W 115 40' 106 7,501. sq.ft. 7,764/sq.ft. 0.19 acres **167** 8,539. sq.ft. 0.19 acres 7,501. sq.ft. 0.17 acres COMMON AREA 43 7,501. sq.ft. 7,501. sq.ft. 0.172 acres 166 100 8,125. sq.ft. 0.18 acres 8,476. sq.ft 0.19 acres 0.20 acres 108 8,476. sq.ft 0.19 acres 8,476. sq.ft 0.19 acres 8,996. sq.ft. 0.18 acres 8,670. sq.ft. **110** 8,476. sq.ft 0.19 acres 8,932. sq.ft. **42** 12,008. sq.ft 0.276 acres 0.20 acres 0.20 acres 165 COMMON AREA 8,125. sq.ft. **125**11,250. sq.ft. 0.18 acres 193 8,752. sq.ft. 0.201 acres 164 **8,**125. sq.ft. 0.18 acres **126** 10,537. sq.ft. **169** 11,406. sq.ft. 0.26 acres 194 7,501, sq.ft. 0.17 acres 172 7,501. sq.ft. 0.17 acres 173 11,983. sq.tt. 0.26 acres 8,493. sq.ft. ₹ 161 187 11,711. sq.ft. 0.27 acres **188** 7,503. sq.ft 0.17 acres 0.19 acres **190** 7,503. sq.ft 0.17 acres **191** 7,534. sq.ft. 0.17 acres 160 9,378. sa.ft. 0.21 acres/ 159 0.17 acres /0.18 acres 9,632. sq.ft. 0.22 acres JAMES J. MEEHAN, P.E. SANITARY SEWER SCHEDULE: MH# TOP EL. INV. SOUTH NORTH EAST WEST 1221 SW 96th STREET GAINESVILLE, FLORIDA 32607 Ph. (352) 215-2548 Fx. (352) 332-0431 DESCRIPTION DRAWN BY: SPL CHECKED BY: JM SCALE: 1" = 50'XXXX SW X th STREET ALACHUA, FLORIDA UTILITY PLAN PHASE 2 NORTH DATE: 08/29/15 JOB NUMBER SHEET DESCRIPTION: Utility Plan ph 2 north XX ID

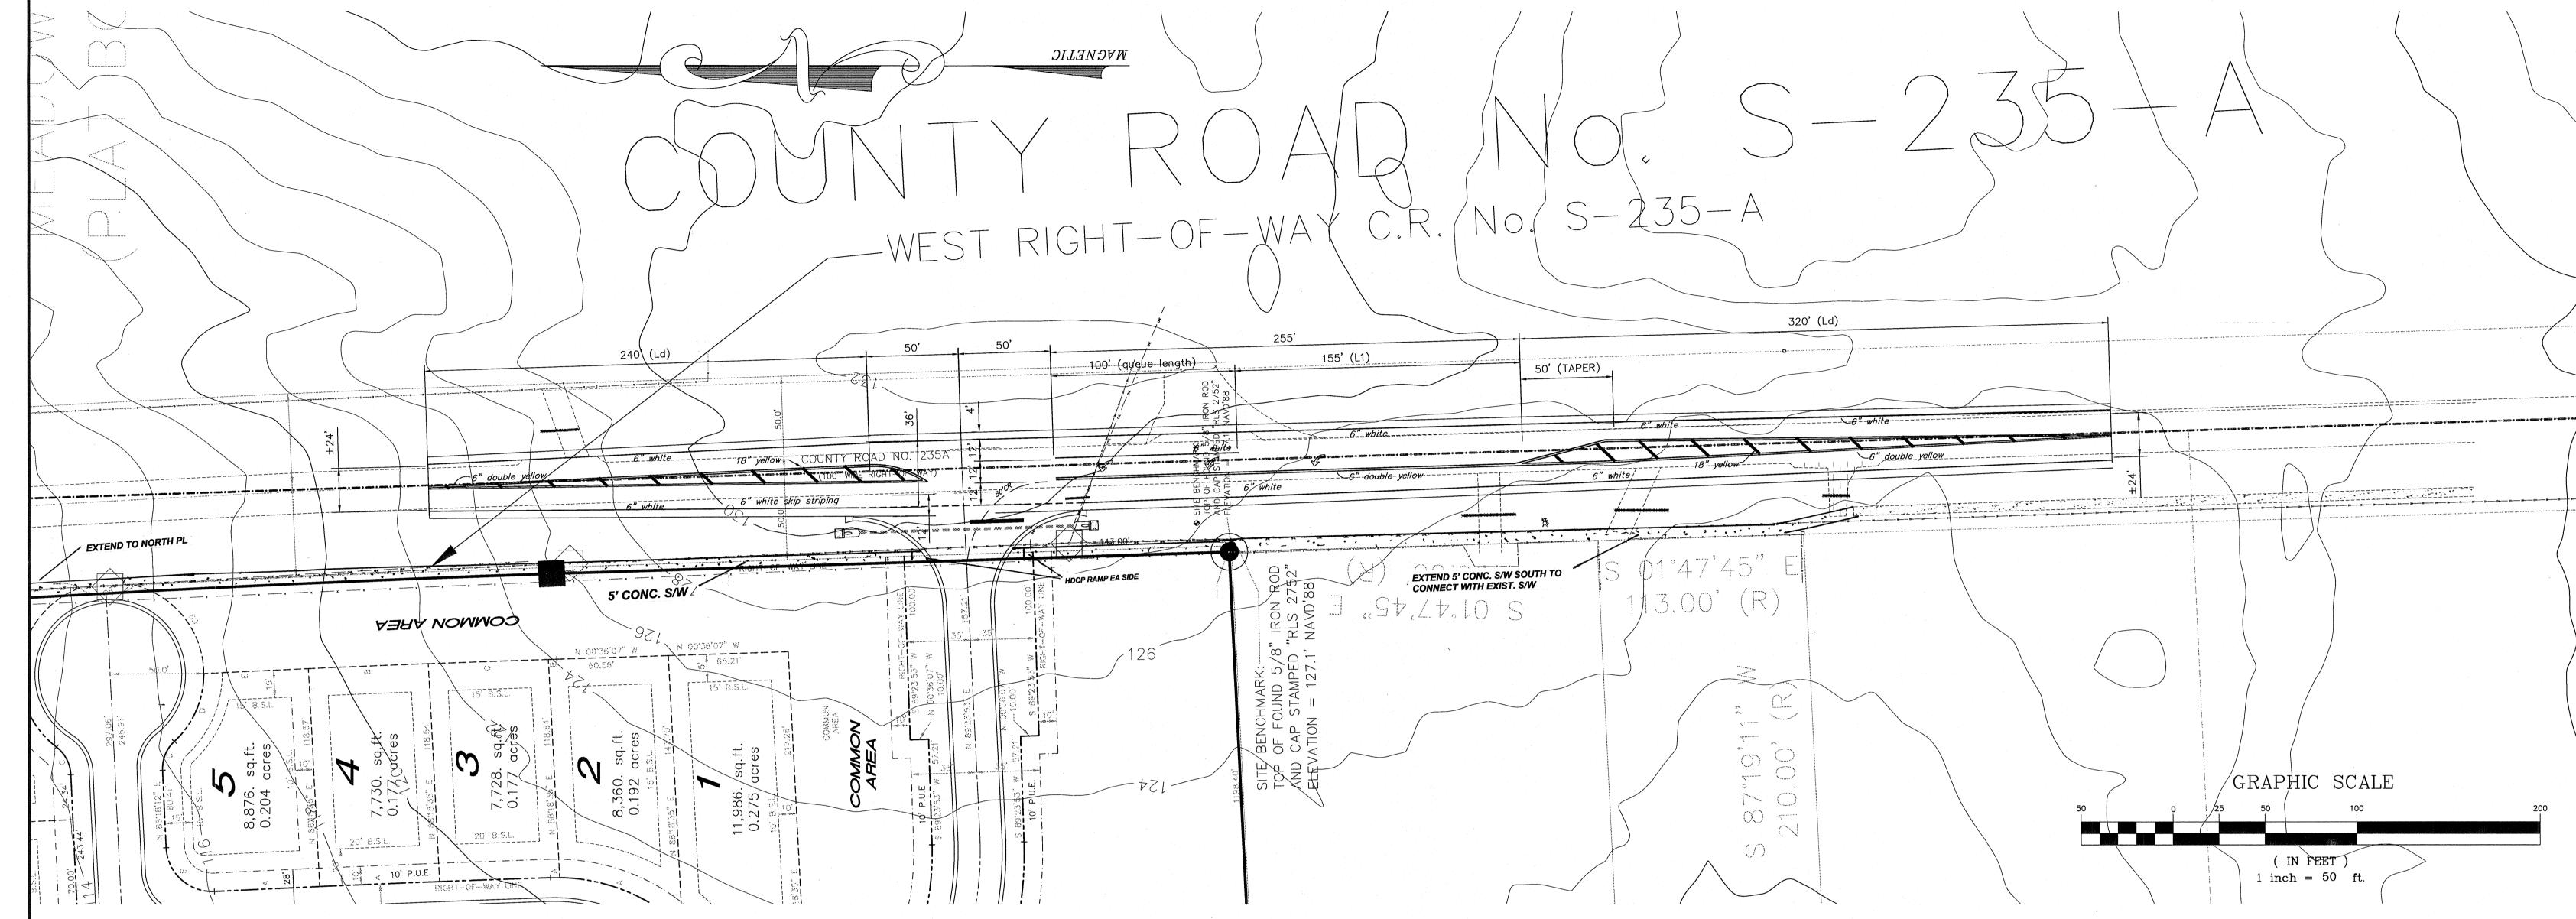BENTON HILLS PH 2 8,932. sq.ft. ...0.20 acres 0.19 acres 0.19 acres 0.18 acres 0.19 acres COMMON AREA 0.18 acres 8,752. sq.ft. 0.201 acres 164 0.18 acres 169 194 10,537. sq.ft. 11,406. sq.ft. 0.26 acres 8,493. sq.ft. 187 11,983. sq.\ft. 0.19 acres **191** 7,534. sq.ft. 11,711. sq.ft. 0.26 acres 160 9,378. sq.ft. 7,503. sq.ft 0.27 acres 0.17 acres 159 0.17 acres 9,632. sq.ft. 0.22 acres 7,511. sq.ft. 186 0.17 acres 8,564. sq.ft. 158 0.19 acres **3,**564. sq.ft. COMMON AREA 8,597. sq.ft. 0.19 acres 11,355. sq.ft. 128 0.17 acres 0.26 acres/ 196 7,501. sq.ft. 7,501. sq.ft. 185 0.17 acres 0.17 acres 8,564. sq.ft. 209 0.19 acres 8,564. sq.ft. 157 8,544. sq.ft. 0.19 acres 0.17 acres 7,701. sq.ft. 0.17 acres 7,501. sq.ft. 7,501 (sq.ft. 0.17 acres 176 8,564. sg.ft. 0.19 øcres COMMON AREA 8,564. sq.ft. 8,544. sq.ft. 0.19 acres 0.17 acres 7,585. sq.ft. 0.17 acres 183 SANITARY 8,564. sq.ft. 207 7,501. sq.ft. 0.19 acres SEWER LIFT COMMON AREA 8,564. sq.ft. 0.17 acres 155 8,544. sq.ft. 0.19 acres 7,501. sq.ft. STATION 0.17 acres 7,532, sq.ft. 0.17 acres 0.17 acres TO BE CONSTRUCTED PER CITY OF ALACHUA STANDARDS 163 199 131 182 **154** 7,703. sq.ft. 0.17 acres **180** 7,524. sq.ft. 0.17 acres 178 7,501. sq.ft. 0.17 acres 11,613. sq.ft. 0.26 acres 7,524. sq.ft. 0.17 acres 11,291. sq.ft. 0.17 acres **201**12,411. sq.ft. 0.28 acres 0.26 acres 0.26 acres 200 0.19 acres 0.19 acres 9,927. sq.ft. 132 0.23 acres 153 8,843. sq.ft. 13,509. sq.ft. -NW 170TH RD -0.31 acres 152 12,113. sq.ft. **151** 8,849. sq.ft. 149 8,952. sg.ft. 148 7,503. sq.ft 0.17 acres 0.28 øcres 0.20 øcres **141** 7,509. sq.ft. 0.17 agres /**140** 7,509. sq.ft c0.17 acres 139 **138** 7,509. sq.ft 0.17 acres 136 7,509. sq.ft 7,509. sq.ft 0.17 acres 0.17 acres _90.0-84.0 -RETENTION AREA 2 JAMES J. MEEHAN, P.E. SANITARY SEWER SCHEDULE: MH# TOP EL. INV. SOUTH NORTH EAST WEST 1221 SW 96th STREET GAINESVILLE, FLORIDA 32607 Ph. (352) 215-2548 Fx. (352) 332-0431 DESCRIPTION DRAWN BY: SPL CHECKED BY: JM SCALE: 1" = 50'LOCATION: XXXX SW X th STREET ALACHUA, FLORIDA UTILITY PLAN PHASE 2 SOUTH DATE: 08/29/15 JOB NUMBER SCALE: 1" = 50'DESCRIPTION: Utility Plan ph 2 SOUTH XX II 🛆



STRIPING PER FDOT INDEX 17346 AND 526

SOD ALL DISTURBED AREAS OF RIGHT-OF-WAY

CENTERED WIDENING LEFT TURN STORAGE LANE SCALE: 1" = 50'

PROPOSED ASPHALT MILLING: MILL 1 1/2" DEEP OVER THE ENTIRE LENGTH & WIDTH OF THE EXISTING ASPHALT DRIVE LANES WITHIN THE CENTER UNDENING. ADD 1 1/2" FC 12.5 FRICTION COURSE ONTO THE MILLED SURFACE ALONG WITH THE WIDENING. COURSE COUNTY ROAD 235-A WIDENING COURSE. 1 1/2" TYPE FC 12.5 OVERLAY SOD ALL DISTURBED AREAS SOD ALL DISTURBED AREAS MILLING AREA & FC 12.5 FRICTION COURSE - (2) 1 1/2" S-I STRUCTURAL ASPHALTIC COURSES WITH ---1 1/2" FC 12.5 ASPHALTIC CONCRETE FRICTION COURSE, ON 2.0% SLOPE. PROVIDE LEVELING COURSE (IF NECESSARY) 1 1/2" FC 12.5 FRICTION COARSE, --1 1/2" FC 12.5 FRICTION COARSE, -12" PRIMED LIMEROCK BASE (LBR 100 COMPACTED TO ---4" LIMEROCK BASE (LBR 100) MIN. 98% COMP. DENSITY AASHTO T-180 OVER UNYIELDING SUBGRADE 4" LIMEROCK BASE (LBR 100) MIN. 98% COMP. DENSITY AASHTO T-180 OVER UNYIELDING SUBGRADE 98% MODIFIED PROCTOR DENSITY PER AASHTO T-180) —12" STABILIZED SUBGRADE WITH MIN. LBR OF 40 — (98% COMP. PER AASHTO T-180)

***** ALL RECYCLABLE AND REUSABLE MATERIALS, AS DESIGNATED BY THE COUNTY ENGINEER, WITHIN THE COUNTY RIGHT-OF-WAY SHALL REMAIN THE PROPERTY OF ALACHUA COUNTY. THE MILLED MATERIAL SHALL BE DELIVERED BY THE CONTRACTOR TO THE ACPW COMPOUND IN HAGUE. CONTRACTOR SHALL COORDINATED WITH MR. LEWIS KING, ROAD SUPERINTENDENT, AT 352-374-5245 X216.

TYPICAL CENTERED WIDENING LEFT TURN STORAGE LANE SECTION

BY-PASS LANE

EROSION AND SEDIMENT CONTROL NOTES:

1. SEDIMENT BARRIERS/SCREENS AND OTHER MEASURES INTENDED TO TRAP SEDIMENT SHALL BE CONSTRUCTED OR INSTALLED AS A FIRST STEP IN ANY LAND DISTURBING ACTIVITY AND SHALL BE MADE FUNCTIONAL BEFORE UPSLOPE LAND DISTURBANCE OCCURS. ALL EROSION AND SEDIMENT CONTROL DEVICES SHALL CONFORM TO THE LATEST FDOT AND ACPW STANDARDS AND SPECIFICATIONS, REFER TO FDOT STD INDEX NO. 102

2. ALL SEDIMENT CONTROL MEASURES ARE TO BE ADJUSTED TO MEET FIELD CONDITIONS AND BE INSTALLED PRIOR TO ANY GRADING OF EXISTING SURFACE MATERIAL ON THE BALANCE OF THE SITE. AT THE START OF CONSTRUCTION, PERIMETER BARRIERS SHALL BE CONSTRUCTED TO PREVENT SEDIMENT OR TRASH FROM FLOWING OR FLOATING OFF SITE ONTO ADJACENT LANDS.

3. PERMENANT OR TEMPORARY SOIL STABILIZATION SHALL BE APPLIED TO ALL AREAS WHERE WORK HAS BEEN COMPLETED WITHIN TWO WEEKS OF COMPLETION OF WORK IN THAT PARTICULAR AREA.

4. SEDIMENT CONTROL STRUCTURES, BARRIERS, AND SCREENS SHALL BE INSPECTED WEEKLY TO INSURE PROPER FUNCTION, AND ALSO BE INSPECTED AFTER ANY RAINFALL EVENT EXCEEDING .5". ANY DAMAGED EROSION AND SEDIMENT CONTROL DEVISES SHALL BE

REPAIRED IMMEDIATELY. THE DEVELOPER, OWNER, AND CONTRACTOR SHALL BE RESPONSIBLE FOR ALL SEDIMENT LEAVING THE PROPERTY, SEDIMENT CONTROL DEVICES SHALL BE IN WORKING ORDER AT THE END OF EACH WORKDAY

5. ANY CONCENTRATED RUNOFF SHALL NOT BE ALLOWED TO FLOW DOWN CUT OR FILL SLOPES UNLESS CONTAINED IN TEMPORARY CHANNELS DRAIN STRUCTURES

6. SEDIMENT THAT ENTERS THE STORMWATER SYSTEM SHALL BE FILTERED THRU SCREENS, HAY BALES ETC. DURING THE CONSTRUCTION PROCESS TO MINIMIZE SEDIMENT TRANSPORT. PRIOR TO FINAL STABILIZATION SEDIMENT SHALL BE REMOVED AND REGRADED ON THE SITE OR DISPOSED OF AT PERMITTED LOCATION.

7. AT THE END OF EACH DAY WHERE CONSTRUCTION VEHICLE ACCESS ROADS INTERSECT PAVED PUBLIC STREETS, PROVISIONS SHALL BE MADE TO LIMIT THE TRANSPORT OF SEDIMENT BY TRACKING ONTO THE EXISTING PAVED STREET. ANY SEDIMENT DEPOSITED ONTO THE EXISTING PAVED STREET SHALL BE SWEPT OR SHOVELED OFF AND REGRADED ON SITE OR REMOVED TO A PERMITTED LOCATION

8. ALL TEMPORARY EROSION CONTROL DEVISES SHALL BE REMOVED WITHIN 30 DAYS AFTER FINAL SITE STABILIZATION HAS OCCURRED.

9. ANY STOCKPUED MATERIAL SHALL BE PLACED TO MINIMIZE THE CHANCE FOR SEDIMENT TRANSPORT AND SHALL NOT BE PLACED TO

9. ANY STOCKPILED MATERIAL SHALL BE PLACED TO MINIMIZE THE CHANCE FOR SEDIMENT TRANSPORT AND SHALL NOT BE PLACED TO IMPEDE THE NATURAL RUNOFF

10. SOD SHALL BE PLACED AS INDICATED ON THE PLANS AND AROUND ALL HEADWALLS, MITERED ENDS ETC. IN ACCORDANCE WITH THE DESIGN STANDARDS OF THE FDOT. ALL SOD TO BE CERTIFIED APPARENTLY WEED FREE.

11. EROSION PROTECTION WITH ENERGY DISSIPATERS IF REQUIRED (VELOCITY OVER 3FT/SEC) SHALL BE INSTALLED/CONSTRUCTED AT THE

TIME OF CONSTRUCTION OF THE OUTLET. FOR VELOCITIES LESS THAN 3FT/SEC PEGGED SOD IS TO BE INSTALLED.

12. DURING CONSTRUCTION, DISTURBANCE AND COMPACTION OF THE RETENTION BOTTOM SHALL BE KEPT TO A MINIMUM

JAMES J. MEEHAN, P.E.

1221 SW 96th STREET
GAINESVILLE, FLORIDA 32607

Ph. (352) 215-2548 Fx. (352) 332-0431

REV. DESCRIPTION BY DATE

BY DATE

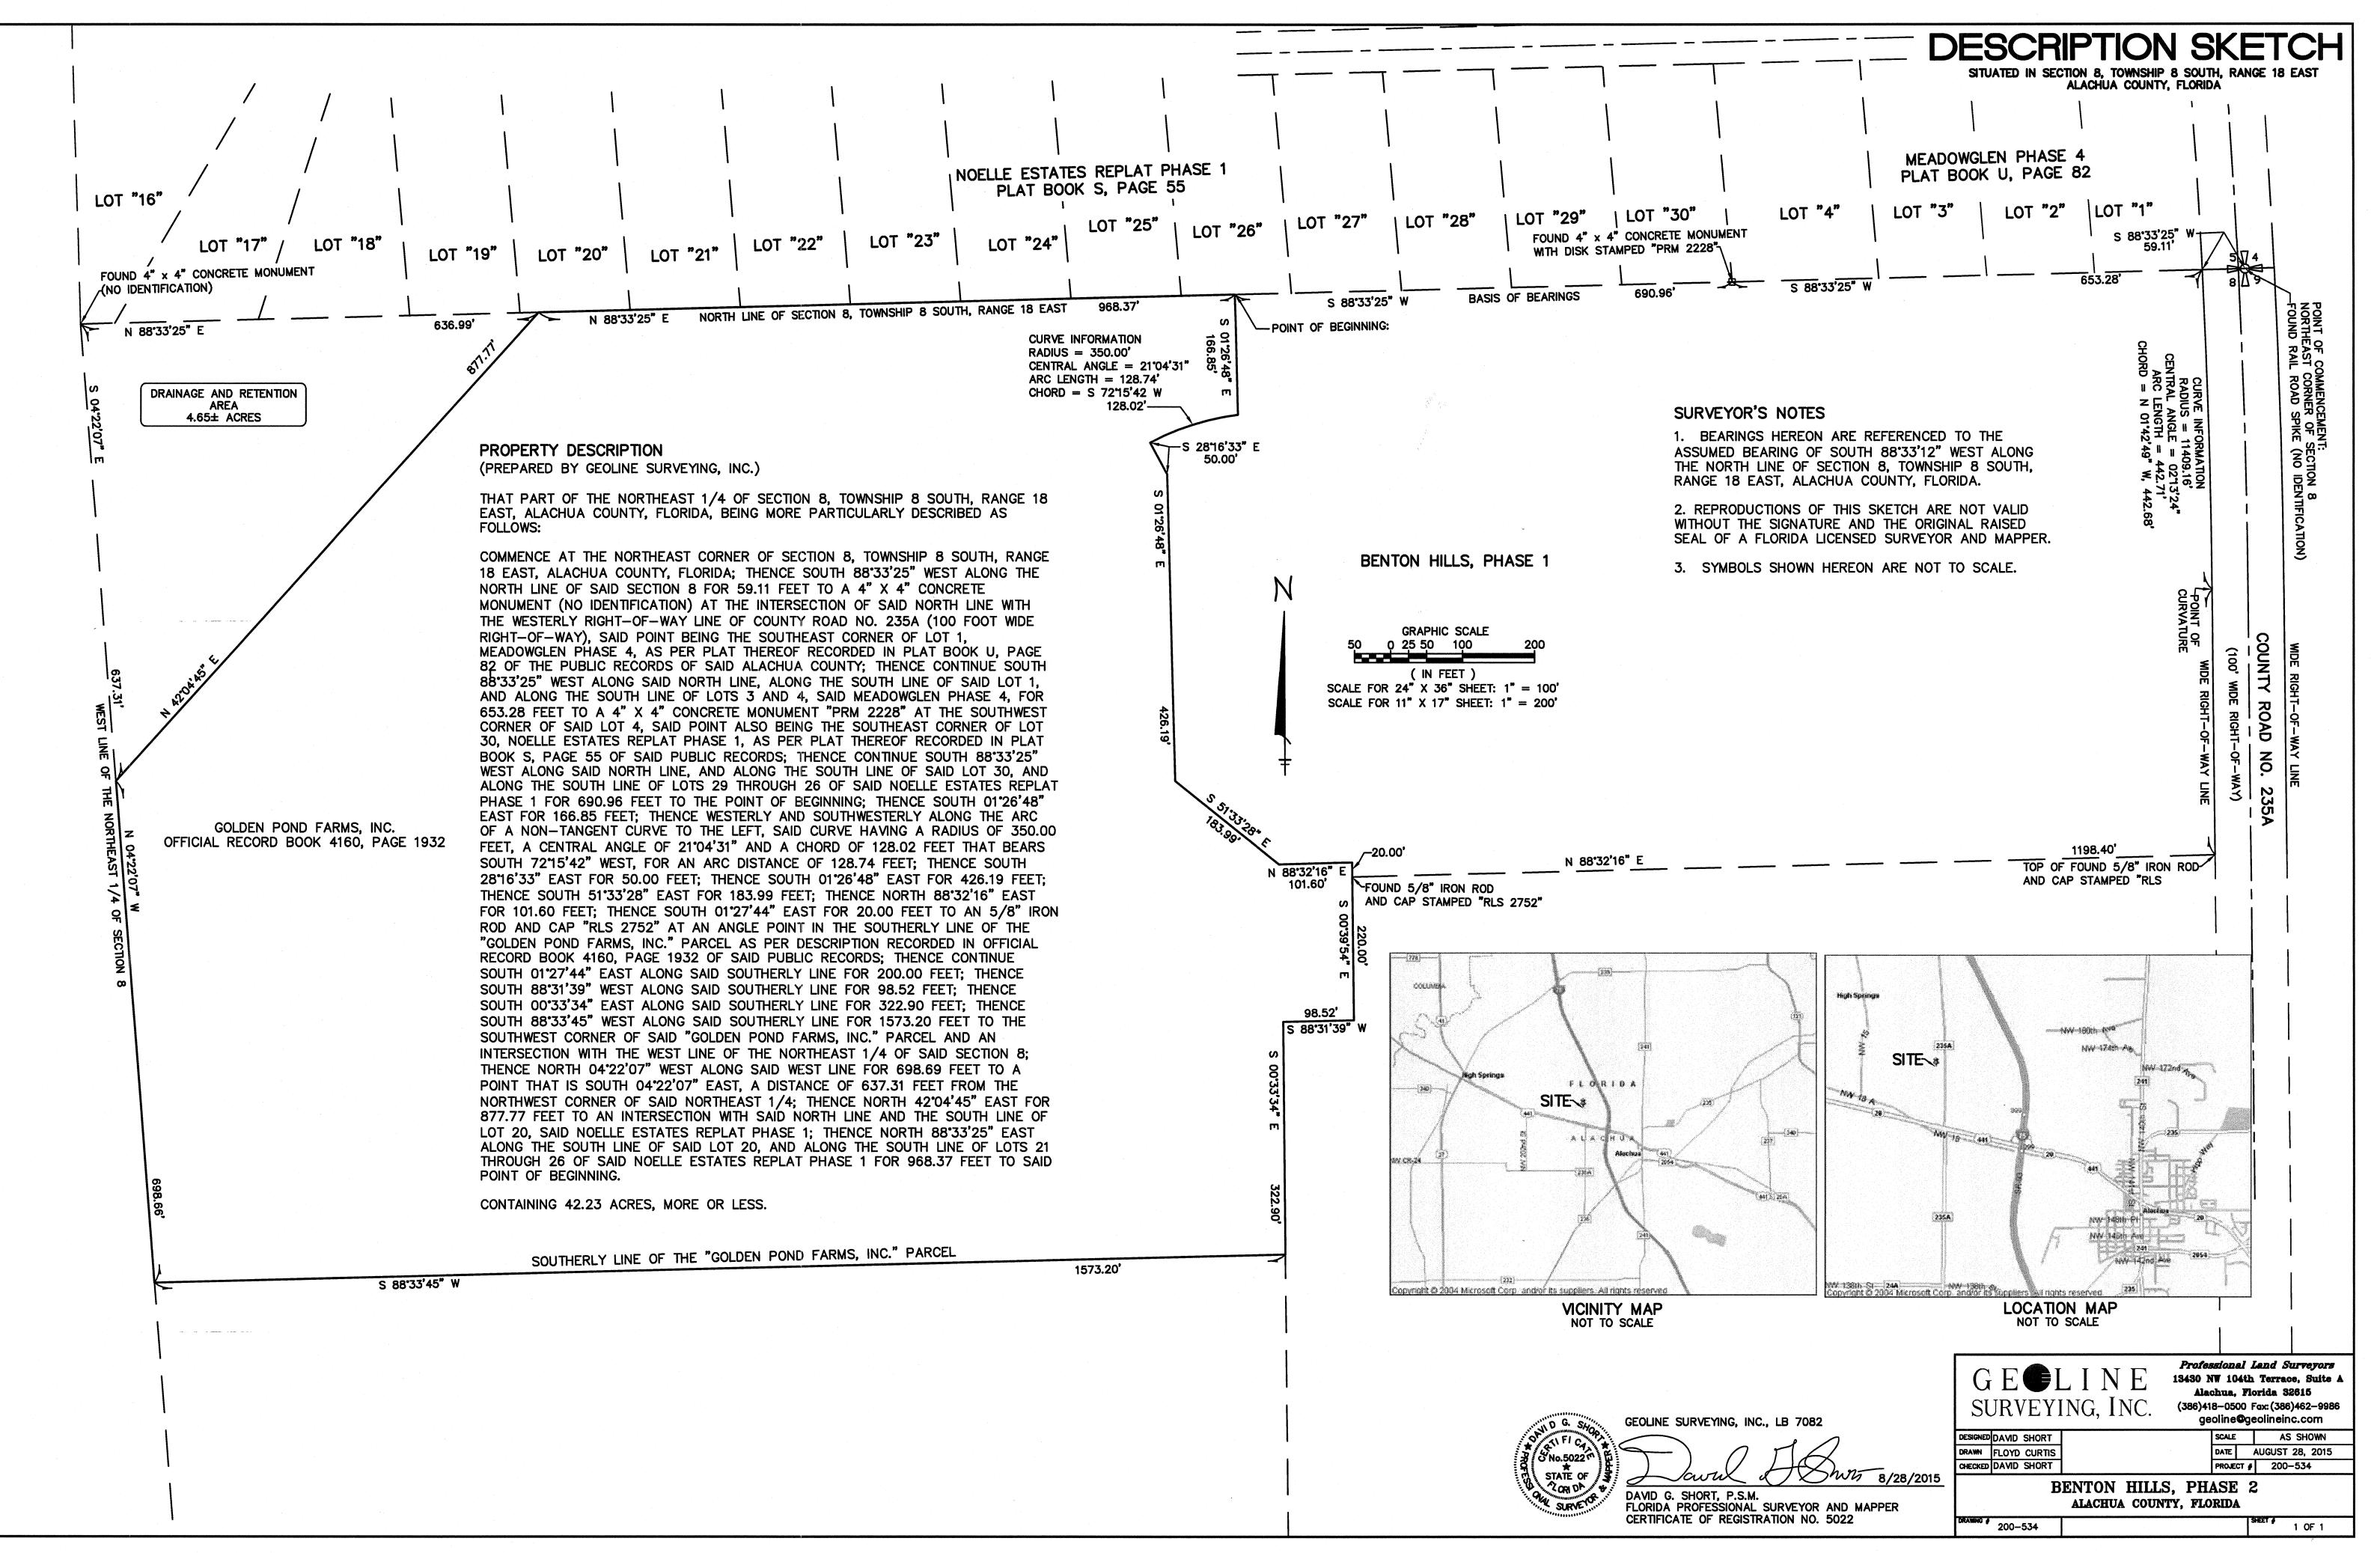
DATE: 08/29/15

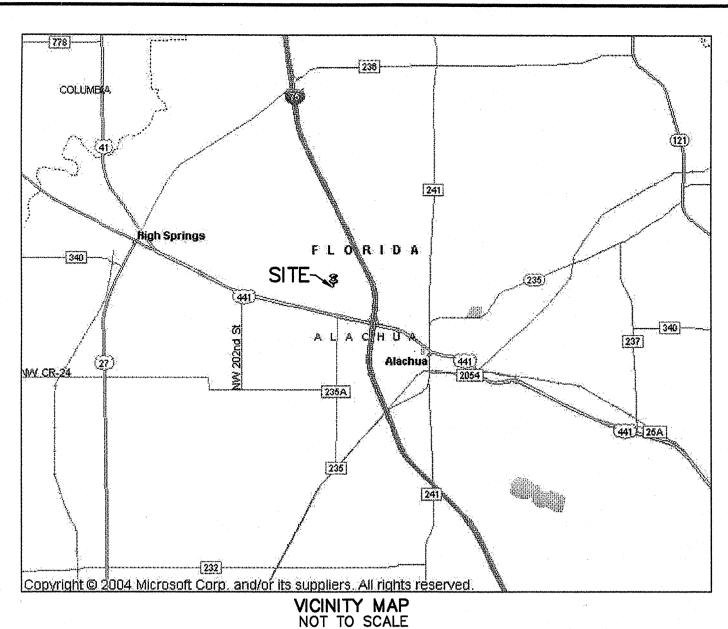
JOB NUMBER

DATE

DATE: 08/29/15

DATE: 08/29/15







SURVEYOR'S NOTES

1. BEARINGS HEREON ARE REFERENCED TO THE ASSUMED BEARING OF SOUTH 88°33'25" WEST ALONG THE SOUTH LINE OF NOELLE ESTATES REPLAT PHASE 1 AND NOELLE ESTATES REPLAT PHASE 2, AS PER PLAT THEREOF RECORDED IN PLAT BOOK S, PAGE 55 OF THE PUBLIC RECORDS OF ALACHUA COUNTY, FLORIDA.

2. THE ERROR OF CLOSURE OF THE BOUNDARY OF THE PROPERTY THAT IS THE SUBJECT OF THIS PLAT DOES NOT EXCEED 1/15,000.

3. ALL PLATTED PUBLIC UTILITY EASEMENTS SHALL PROVIDE THAT SUCH EASEMENTS SHALL ALSO BE EASEMENTS FOR THE CONSTRUCTION, INSTALLATION, MAINTENANCE, AND OPERATION OF CABLE TELEVISION SERVICES; PROVIDED, HOWEVER, NO SUCH CONSTRUCTION, INSTALLATION, MAINTENANCE, AND OPERATION OF CABLE TELEVISION SERVICES SHALL INTERFERE WITH THE FACILITIES AND SERVICES OF AN ELECTRIC, TELEPHONE, GAS, OR OTHER PUBLIC UTILITY IN THE EVENT A CABLE TELEVISION COMPANY DAMAGES THE FACILITIES OF A PUBLIC UTILITY, IT SHALL BE SOLELY RESPONSIBLE FOR THE DAMAGES. THIS SECTION SHALL NOT APPLY TO THOSE PRIVATE EASEMENTS GRANTED TO OR OBTAINED BY A PARTICULAR ELECTRIC, TELEPHONE, GAS, OR OTHER PUBLIC UTILITY. SUCH CONSTRUCTION, INSTALLATION, MAINTENANCE, AND OPERATION SHALL COMPLY WITH THE NATIONAL ELECTRICAL SAFETY CODE AS ADOPTED BY THE FLORIDA PUBLIC SERVICE COMMISSION.

- 4. A 1/2" REBAR & CAP (GEOLINE LB 7082) SHALL BE SET AT EACH LOT CORNER PER FLORIDA STATUTE 177.091(9) UNLESS SHOWN AS A PERMANENT REFERENCE MONUMENT.
- 5. THE LOTS SHOWN HEREON ARE SUBJECT TO RESTRICTIVE COVENANTS WHICH WILL BE RECORDED IN THE PUBLIC RECORDS OF ALACHUA COUNTY, FLORIDA CONTEMPORANEOUS WITH THE RECORDING OF THIS PLAT.
- 6. THE BOUNDARY OF THIS SUBDIVISION, AS SHOWN HEREON, DOES NOT LIE WITHIN A 0.5 MILE RADIUS OF ANY EXISTING HORIZONTAL GEODETIC CONTROL MONUMENT ESTABLISHED BY THE ALACHUA COUNTY CONTROL DENSIFICATION SURVEY OR ESTABLISHED BY NATIONAL GEODETIC SURVEY.
- 7. THE PARCEL SHOWN HEREON DOES NOT LIE WITHIN A SPECIAL FLOOD HAZARD AREA AS DESIGNATED ON COMMUNITY PANEL NUMBER 120664 0110 D OF THE FEDERAL EMERGENCY MANAGEMENT AGENCY (FEMA) NATIONAL FLOOD INSURANCE PROGRAM (NFIP) FLOOD INSURANCE RATE MAP (FIRM) FOR THE CITY OF ALACHUA, ALACHUA COUNTY, FLORIDA, DATED 6/16/2006.
- 8. ELEVATIONS SHOWN HEREON ARE BASED UPON GPS OBSERVATIONS AND ARE REFERENCED TO THE NORTH AMERICAN VERTICAL DATUM 1988.
- 9. ALL STRAIGHT LINES INTERSECTING CURVED LINES ARE NON-RADIAL UNLESS INDICATED OTHERWISE.
- 10. BUILDING SETBACK REQUIREMENTS (MINIMUM) UNLESS OTHERWISE SHOWN.

PRIMARY BU	<u> JILDING</u>
FRONT	20'
SIDES	10'
REAR	15'
SIDE STREET	Γ 15'

BENTON HILLS, PHASE 1

THAT PART OF THE NORTHEAST 1/4 OF SECTION 8, TOWNSHIP 8 SOUTH,

RANGE 18 EAST, ALACHUA COUNTY, FLORIDA, BEING MORE PARTICULARLY

COMMENCE AT THE NORTHEAST CORNER OF SECTION 8, TOWNSHIP 8

SOUTH, RANGE 18 EAST, ALACHUA COUNTY, FLORIDA: THENCE SOUTH

88°33'25" WEST ALONG THE NORTH LINE OF SAID SECTION 8 FOR 59.11 FEET TO A 4" X 4" CONCRETE MONUMENT (NO IDENTIFICATION) AT THE INTERSECTION OF SAID NORTH LINE WITH THE WESTERLY RIGHT-OF-WAY

LINE OF COUNTY ROAD NO. 235A (100 FOOT WIDE RIGHT-OF-WAY), SAID POINT BEING THE SOUTHEAST CORNER OF LOT 1, MEADOWGLEN PHASE 4,

BEGINNING: THENCE CONTINUE SOUTH 88°33'25" WEST ALONG SAID NORTH

OF LOTS 3 AND 4, SAID MEADOWGLEN PHASE 4, FOR 653.28 FEET TO A

4" X 4" CONCRETE MONUMENT "PRM 2228" AT THE SOUTHWEST CORNER

OF SAID LOT 4, SAID POINT ALSO BEING THE SOUTHEAST CORNER OF LOT 30, NOELLE ESTATES REPLAT PHASE 1, AS PER PLAT THEREOF RECORDED

IN PLAT BOOK S, PAGE 55 OF SAID PUBLIC RECORDS; THENCE CONTINUE SOUTH 88'33'25" WEST ALONG SAID NORTH LINE, AND ALONG THE SOUTH

LINE OF SAID LOT 30, AND ALONG THE SOUTH LINE OF LOTS 29 THROUGH

26 OF SAID NOELLE ESTATES REPLAT PHASE 1 FOR 690.96 FEET; THENCE

EAST FOR 50.00 FEET; THENCE SOUTH 01°26'48" EAST FOR 426.19 FEET; THENCE SOUTH 51°33'28" EAST FOR 183.99 FEET; THENCE NORTH 88°32'16"

EAST FOR 101.60 FEET; THENCE SOUTH 01'27'44" EAST FOR 20.00 FEET

DESCRIPTION RECORDED IN OFFICIAL RECORD BOOK 4299, PAGE 972 OF SAID PUBLIC RECORDS; THENCE NORTH 88'32'16" EAST ALONG THE NORTH

LINE OF SAID "CHARLES R. SMYDER TRUSTEE" PARCEL FOR 1198.40 FEET TO A 5/8" IRON ROD AND CAP STAMPED "RLS 2752" AT THE NORTHEAST

CORNER OF SAID "CHARLES R. SMYDER TRUSTEE" PARCEL AND THE INTERSECTION WITH SAID WESTERLY RIGHT-OF-WAY LINE; THENCE NORTH 00'36'07" WEST ALONG SAID WESTERLY RIGHT-OF-WAY LINE FOR 368.48

FEET TO THE POINT OF CURVATURE OF A CURVE TO THE LEFT, SAID

02"13"24" AND A CHORD OF 442.68 FEET THAT BEARS NORTH 01"42"49"

THAT PART OF THE NORTHEAST 1/4 OF SECTION 8, TOWNSHIP 8 SOUTH, RANGE 18 EAST, ALACHUA COUNTY, FLORIDA, LYING WITHIN 25 FEET OF

BOTH SIDES OF A CENTERLINE BEING MORE PARTICULARLY DESCRIBED AS

COMMENCE AT THE NORTHEAST CORNER OF SECTION 8, TOWNSHIP 8

SOUTH, RANGE 18 EAST, ALACHUA COUNTY, FLORIDA; THENCE SOUTH

88'33'25" WEST ALONG THE NORTH LINE OF SAID SECTION 8 FOR 59.11 FEET TO A 4" X 4" CONCRETE MONUMENT (NO IDENTIFICATION) AT THE

INTERSECTION OF SAID NORTH LINE WITH THE WESTERLY RIGHT-OF-WAY

LINE OF COUNTY ROAD NO. 235A (100 FOOT WIDE RIGHT-OF-WAY), SAID

POINT BEING THE SOUTHEAST CORNER OF LOT 1, MEADOWGLEN PHASE 4,

BEGINNING; THENCE CONTINUE SOUTH 88'33'25" WEST ALONG SAID NORTH

OF LOTS 3 AND 4, SAID MEADOWGLEN PHASE 4, FOR 653.28 FEET TO A 4" X 4" CONCRETE MONUMENT "PRM 2228" AT THE SOUTHWEST CORNER

OF SAID LOT 4, SAID POINT ALSO BEING THE SOUTHEAST CORNER OF LOT

30, NOELLE ESTATES REPLAT PHASE 1, AS PER PLAT THEREOF RECORDED

IN PLAT BOOK S, PAGE 55 OF SAID PUBLIC RECORDS; THENCE CONTINUE

SOUTH 88°33'25" WEST ALONG SAID NORTH LINE, AND ALONG THE SOUTH

LINE OF SAID LOT 30, AND ALONG THE SOUTH LINE OF LOTS 29 THROUGH

26 OF SAID NOELLE ESTATES REPLAT PHASE 1 FOR 690.96 FEET; THENCE

LEFT, SAID CURVE HAVING A RADIUS OF 350.00 FEET, A CENTRAL ANGLE

WEST, FOR AN ARC DISTANCE OF 128.74 FEET; THENCE SOUTH 281633"

OF 21°04'31" AND A CHORD OF 128.02 FEET THAT BEARS SOUTH 72°15'42"

EAST FOR 25.00 FEET TO THE POINT OF BEGINNING OF THE CENTERLINE OF

FEET THAT BEARS SOUTH 55°04'36" WEST. FOR AN ARC DISTANCE OF 75.41

CENTRAL ANGLE OF 46'02'56" AND A CHORD OF 195.56 FEET THAT BEARS

POINT OF TANGENCY: THENCE SOUTH 88°33'12" WEST FOR 515.68 FEET TO

THE POINT OF CURVATURE OF A CURVE TO THE LEFT, SAID CURVE HAVING

A RADIUS OF 200.00 FEET, A CENTRAL ANGLE OF 46'28'27" AND A CHORD

SOUTHWESTERLY ALONG THE ARC OF SAID CURVE FOR 162.23 FEET TO A

POINT OF TANGENCY; THENCE SOUTH 42'04'45" WEST FOR 466.68 FEET TO

THE POINT OF CURVATURE OF A CURVE TO THE LEFT, SAID CURVE HAVING

A RADIUS OF 200.00 FEET, A CENTRAL ANGLE OF 46'28'06" AND A CHORD

OF 157.80 FEET THAT BEARS SOUTH 18°50'42" WEST. THENCE SOUTHERLY

ALONG THE ARC OF SAID CURVE FOR 162.20 FEET TO A POINT OF

TANGENCY; THENCE SOUTH 04°23'21" WEST FOR 233.17 FEET TO THE

SOUTH 01°26'48" EAST FOR 166.85 FEET; THENCE WESTERLY AND

SOUTHWESTERLY ALONG THE ARC OF A NON-TANGENT CURVE TO THE

THE HEREIN DESCRIBED 50 FOOT WIDE INGRESS, EGRESS AND PUBLIC

NON-TANGENT CURVE TO THE LEFT, SAID CURVE HAVING A RADIUS OF 325.00 FEET, A CENTRAL ANGLE OF 13°17'42" AND A CHORD OF 75.24

FEET: THENCE NORTHWESTERLY ALONG THE ARC OF A NON-TANGENT

CURVE TO THE LEFT, SAID CURVE HAVING A RADIUS OF 325.00 FEET, A

NORTH 68'25'20" WEST, FOR AN ARC DISTANCE OF 200.93 FEET TO A

OF 157.81 FEET THAT BEARS SOUTH 65'18'58" WEST, THENCE

POINT OF TERMINUS OF THE HEREIN DESCRIBED CENTERLINE.

CONTAINING 2.09 ACRES±

UTILITY EASEMENT; THENCE SOUTHWESTERLY ALONG THE ARC OF A

LINE, ALONG THE SOUTH LINE OF SAID LOT 1, AND ALONG THE SOUTH LINE

AS PER PLAT THEREOF RECORDED IN PLAT BOOK U, PAGE 82 OF THE

PUBLIC RECORDS OF SAID ALACHUA COUNTY, AND THE POINT OF

WEST, THENCE NORTHERLY ALONG THE ARC OF SAID CURVE FOR 442.71

CURVE HAVING A RADIUS OF 11409.16 FEET, A CENTRAL ANGLE OF

50 FOOT WIDE INGRESS, EGRESS AND PUBLIC UTILITY EASEMENT

FEET TO SAID POINT OF BEGINNING.

(PREPARED BY GEOLINE SURVEYING, INC.)

CONTAINING 26.23 ACRES±

FOLLOWS:

TO A 5/8" IRON ROD AND CAP STAMPED "RLS 2752" AT THE NORTHWEST

SOUTH 01°26'48" EAST FOR 166.85 FEET; THENCE WESTERLY AND SOUTHWESTERLY ALONG THE ARC OF A NON-TANGENT CURVE TO THE LEFT, SAID CURVE HAVING A RADIUS OF 350.00 FEET, A CENTRAL ANGLE OF 21°04'31" AND A CHORD OF 128.02 FEET THAT BEARS SOUTH 72°15'42" WEST. FOR AN ARC DISTANCE OF 128.74 FEET: THENCE SOUTH 28°16'33"

CORNER OF THE "CHARLES R. SMYDER TRUSTEE" PARCEL AS PER

LINE, ALONG THE SOUTH LINE OF SAID LOT 1, AND ALONG THE SOUTH LINE

AS PER PLAT THEREOF RECORDED IN PLAT BOOK U, PAGE 82 OF THE PUBLIC RECORDS OF SAID ALACHUA COUNTY, AND THE POINT OF

SITUATED IN SECTION 8, TOWNSHIP 8 SOUTH, RANGE 18 EAST ALACHUA COUNTY. FLORIDA

PROPERTY DESCRIPTIONS

SUBDIVIDED PARCEL

DESCRIBED AS FOLLOWS:

				LOT CUR	VE TABLE		
-	LOT	CURVE	RADIUS	DELTA	LENGTH	CHORD BEARING	CHORD
	1	Α	25.00'	23°35'10"	10.29'	N 3510'55" E	10.22
		В	100.00'	02*40'26"	4.67'	N 45'38'17" E	4.67'
	2	Α	100.00'	42'08'10"	73.54	N 2313'59" E	71.90'
		В	11359.16	0'01'24"	4.65'	S CO*36'49" E	14.65
	3	A	100.00'	2'49'58"	4.94'	N 00°44'55" E	4.94'
- '		В	11244.16	018'26"	60.27	N CO*49'16" W	60.27
		С	11359.16	0'19'44"	65.21'	S CO'47'23" E	65.21
	4	<u> </u>	11244.16	0'19'56"	65.20'	N C1'08'27" W	65.20
		В	11359.16	0'19'44"	65.20'	S 01°07'07" E	65.20'
	5	A	11244.16'	0'17'32"	57.33'	N 01°27'11" W	<u>57.33'</u>
		В	25.00'	90.09,09,	39.34'	N 43*28'38" E	35.40'
		С	20.00'	49*59'41"	17.45'	S 66°26'57" E	<u>16.90'</u>
		D	50.00'	47*36'54"	41.55'	S 65'15'34" E	40.37
		E	11359.16	0'17'14"	56.93'	S 01°25'36" E	56.93
	6	A	11359.16	0'33'19"	110.09'	S 02*21'06" E	110.09
		В	50.00'	46'51'51"	40.90'	S 61*59'26" W	39.77
		C	20.00'	49*59'41"	17.45'	S 63'33'21" W	16.90
٠.	10	Α.	225.00'	15'42'13"	61.67'	S 80°42'06" W	61.48'
	11	A	225.00'	19'52'18"	78.04'	S 62*54'50" W	77.65
	12	A	225.00'	0'46'39"	3.05'	S 52*35'21" W	3.05
		В	25.00'	76*24'43"	33.34'	N 89*35'37" W	30.92
	4 -7	C	225.00'	11"19'12"	44.45	N 57*02'52" W	44.38'
	13 14	A	225.00'	28*44'20"	112.86'	N 77°04'38" W	111.68' 35.34'
	14	B	25.00'	89*56'50" 37*01'48"	39.25'	N 58°32'01" E	111.14
	18	A	175.00'	105*02'01"	113.10' 45.83'	S 57*58'40" E S 38*57'24" E	39.68'
	20	Â	25.00' 300.00'	12*34'21"	65.83'	N 8214'25" E	65.70 '
	21	A	300.00	19'41'36"	103.11	N 66'06'26" E	102.61
	21	B	25.00'	88°15'03"	38.51	N 12'08'07" E	34.81
	22	Ā	25.00	85°45'04"	37.42'	N 10°53'07" E	34.02
		B	175.00	28'38'54"	87.50'	N 68'05'05" E	86.59
	23	A	175.00'	6'08'40"	18.77	S 85'28'52" W	18.76
	24	A	25.00'	89*50'46"	39.20'	N 46'31'25" W	35.31
	2.7	В	11194.16	0°27'40"	90.07	N 01°22'12" W	90.07
	25	A	11194.16	0'21'30"	70.00'	N 00°57'37" W	70.00
	26	A	11194.16	0'06'49"	22.18'	S CO'43'28" E	22.18
		В	50.00'	47'38'34"	41.58'	S 23°09'13" W	40.39
		С	25.00'	101'02'05"	44.08'	N 82°30'28" W	38.59
	27	A	25.00'	23'41'37"	10.34'	S 67*51'27" W	10.26
		В	350.00'	10'15'42"	62.68'	S 61'08'30" W	62.60'
	28	Α	350.00'	11'09'31"	68.16'	N 71*51'06" E	68.06
	29	Α	350.00'	10'44'32"	65.62'	N & 2*48'07" E	65.52
	30	Α	350.00'	0'21'12"	2.16'	N &8'20'59" E	2.16'
	40	A	100.00'	24'28'47"	42.73'	S 7915'06" E	42.40'
	41	A	100.00'	29'03'51"	50.73	S 52'28'47" E	50.18
	42	A	100.00'	36'30'36"	63.72'	S 19'41'34" E	62.65
	47	A	25.00'	99*25'05"	43.38'	N 51°09'20" W	38.14
		В	300.00'	17'24'40"	91.17'	S 70°25'47" W	90.81
	48	A	25.00'	90'00'00"	39.27	S 43'33'12" W	35.36'
	52	A	50.00'	90°02'41"	78.58'	S 46'28'09" E	70.74
	57	A	25.00'	74*56'55"	32.70'	N 51°02'04" E	30.42
	61	A	25.00'	105'00'24"	45.82'	N 38*56'36" W	39.67
	75	<u> </u>	350.00'	5*45'15"	35.15'	N 85*40'35" W	35.13
							and the second second

		CENTERLIN	NE CURVE	TABLE	
CURVE	RADIUS	DELTA	LENGTH	CHORD BEARING	CHORD
CL1	175.00'	58'36'42"	179.02'	S 61'17'46" E	171.31'
CL2	325.00	40*52'03"	231.81'	N 68'05'34" E	226.93'
CL3	75.00'	90'02'41"	117.87	S 46'28'09" E	106.11
CL4	325.00	26'49'45"	152.18'	S 75°08'19" W	150.80'
CL5	200.00'	0*29'18"	1.70'	N 88°47'51" E	1.70'
CL6	200.00'	51°04'08"	178.26'	S 65'25'26" E	172.42'
CL7	325.00	00'41'02"	3.88'	N 47"19'01" E	3.88'
CL8	75.00'	47'38'34"	62.36	N 23'09'13" E	60.58'
CL9	11219.16	01"11'15"	232.52	N 01°15'41" W	232.52'
CL10	200.00'	38*26'34"	134.19'	S 6919'55" W	131.69'
CL11	200.00'	7.53.57"	27.57	S 35°56'24" E	27.55'

		CU	RVE TABLE		
CURVE	RADIUS	DELTA	LENGTH	CHORD BEARING	CHORD
C1	150.00'	44°13'02"	115.76'	S 68'29'36" E	112.91
C2	200.00'	46'53'47"	163.70	S 67°09'13" E	159.17 '
C3	25.00'	56*35'25"	24.69'	S 72'00'02" E	23.70
C4	25.00'	69*46'25"	30.44	S 11'29'52" E	28.60'
C5	175.00'	7*28'21"	22.82	N 35*43'36" W	22.81'
C6	11409.16	00°55'39"	184.71	N 02°21'41" W	184.71
C7	50.00'	75"17'45"	65.71	S 56'55'46" E	61.08'
C8	11409.16	00'09'02"	30.00'	S 01'49'20" E	30.00'
C9	50.00'	75"17'45"	65.71'	N 5317'07" E	61.08'

PROPERTY DESCRIPTIONS
DRAINAGE AND RETENTION AREA

THAT PART OF THE NORTHEAST 1/4 OF SECTION 8, TOWNSHIP 8 SOUTH, RANGE 18 EAST, ALACHUA COUNTY, FLORIDA, BEING MORE PARTICULARLY DESCRIBED AS FOLLOWS:

COMMENCE AT THE NORTHEAST CORNER OF SECTION 8, TOWNSHIP 8 SOUTH, RANGE 18 EAST, ALACHUA COUNTY, FLORIDA; THENCE SOUTH 88°33′25" WEST ALONG THE NORTH LINE OF SAID SECTION 8 FOR 59.11 FEET TO AN 4" X 4" CONCRETE MONUMENT (NO IDENTIFICATION) AT THE INTERSECTION OF SAID NORTH LINE WITH THE WESTERLY RIGHT—OF—WAY LINE OF COUNTY ROAD NO. 235A (100 FOOT WIDE RIGHT—OF—WAY); THENCE CONTINUE SOUTH 88°33′25" WEST ALONG SAID NORTH LINE FOR 2312.61 FEET TO THE POINT OF BEGINNING; THENCE SOUTH 42°04′45" WEST FOR 877.77 FEET TO AN INTERSECTION WITH THE WEST LINE OF THE NORTHEAST 1/4 OF SAID SECTION 8; THENCE NORTH 04°22′07" WEST ALONG SAID WEST LINE FOR 637.31 FEET TO AN 4" X 4" CONCRETE MONUMENT (NO IDENTIFICATION) AT THE NORTHWEST CORNER OF SAID NORTH LINE FOR 636.99 FEET OF SAID POINT OF BEGINNING.

CONTAINING 4.65 ACRES, MORE OR LESS.

PLAT BOOK ____, PAGE_

SHEET 1 OF 6

NOTICE

THIS PLAT, AS RECORDED IN ITS GRAPHIC FORM, IS THE OFFICIAL DEPICTION OF THE SUBDIVIDED LANDS DESCRIBED HEREIN AND WILL IN NO CIRCUMSTANCES BE SUPPLANTED IN AUTHORITY BY ANY OTHER GRAPHIC OR DIGITAL FORM OF THE PLAT. THERE MAY BE ADDITIONAL RESTRICTIONS THAT ARE NOT RECORDED ON THIS PLAT THAT MAY BE FOUND IN THE PUBLIC RECORDS OF THIS COUNTY

OWNERS CERTIFICATION AND DEDICATION

GOLDEN POND FARMS, INC., DOES HEREBY CERTIFY THAT IT IS THE OWNER OF THE LANDS DESCRIBED HEREON, AND HAS CAUSED SAID LANDS TO BE SURVEYED AND PLATTED TO BE KNOWN AS "BENTON HILLS, PHASE 1"; AND DOES HEREBY DEDICATE TO THE PUBLIC FOREVER THE RIGHTS OF WAY AND PUBLIC UTILITIES EASEMENTS AS SHOWN HEREON FOR THE PURPOSE OF INSTALLATION AND MAINTENANCE OF PUBLIC UTILITIES; ALSO, THE DRAINAGE EASEMENTS SHOWN HEREON SHALL BE CONVEYED TO THE BENTON HILLS, PHASE 1 HOMEOWNERS ASSOCIATION, INC. BY SEPARATE CONVEYANCE.

WITNESS	which were later drive made rather calculated bridge bridge street drives which drives driven bridge trained and a street calculated bridge and a street ca
WITNESS	

ACKNOWLEDGMENT

I HEREBY CERTIFY THAT ON THIS DAY PERSONALLY APPEARED BEFORE ME, ERIC J. PARKER, WHO WAS DULY SWORN AND WHO FURNISHED FLORIDA DRIVERS LICENSE AS IDENTIFICATION AND WHO EXECUTED THE ABOVE INSTRUMENT AND ACKNOWLEDGED BEFORE ME THAT HE EXECUTED SAID INSTRUMENT FOR THE USE AND PURPOSE HEREIN EXPRESSED, AND DID TAKE AN OATH.

WITNESS MY	HAND	AND	OFFICIAL	SEAL	THIS	 DAY	OF	 A.D.	2015
NOTARY PUE	3LIC-S	TATE	OF FLORI	DA					
MAY COMMISS	JON EV	DIDEG	2.						

CERTIFICATE OF APPROVAL BY PROFESSIONAL SURVEYOR AND MAPPER
THIS IS TO CERTIFY THAT I REVIEWED THIS PLAT FOR CONFORMITY TO PART 1 OF CHAPTER

AMINED	ONI			
AMINED	OIV.			

PROFESSIONAL SURVEYOR AND MAPPER ROBERT W. GRAVER, P.M.S. 4239

177. FLORIDA STATUES. BUT HAVE NOT VERIFIED THE SURVEY DATA.

CERTIFICATE OF APPROVAL BY THE CITY COMMISSION FOR THE CITY OF ALACHUA, FLORIDA

THIS IS TO CERTIFY, THAT ON ______, THE FOREGOING PLAT WAS APPROVED BY THE CITY COMMISSION OF THE CITY OF ALACHUA, FLORIDA.

CERTIFICATE OF APPROVAL BY THE COUNTY HEALTH DEPARTMENT

ATTEST	·
OLTY MANIA OFF	FILED AND RECORDED ON:
CITY MANAGER	DOOLAL DV THE ATTORNEY
<u> </u>	<u>PROVAL BY THE ATTORNEY</u>
FOR THE CITY OF A	<u>ALACHUA, FLORIDA</u>
EXAMINED ON:	
	GAL FORM & SUFFICIENCY BY:

EXAMINED ON: _____AND APPROVED BY:

CITY ATTORNEY

COUNTY HEALTH DEPARTMENT

RECEIVED AND FILED

RECEIVED AND FILED FOR RECORD ON THIS DAY OF _____, A.D. 2015:

CLERK OF THE COURT DATE

SURVEYOR'S CERTIFICATION

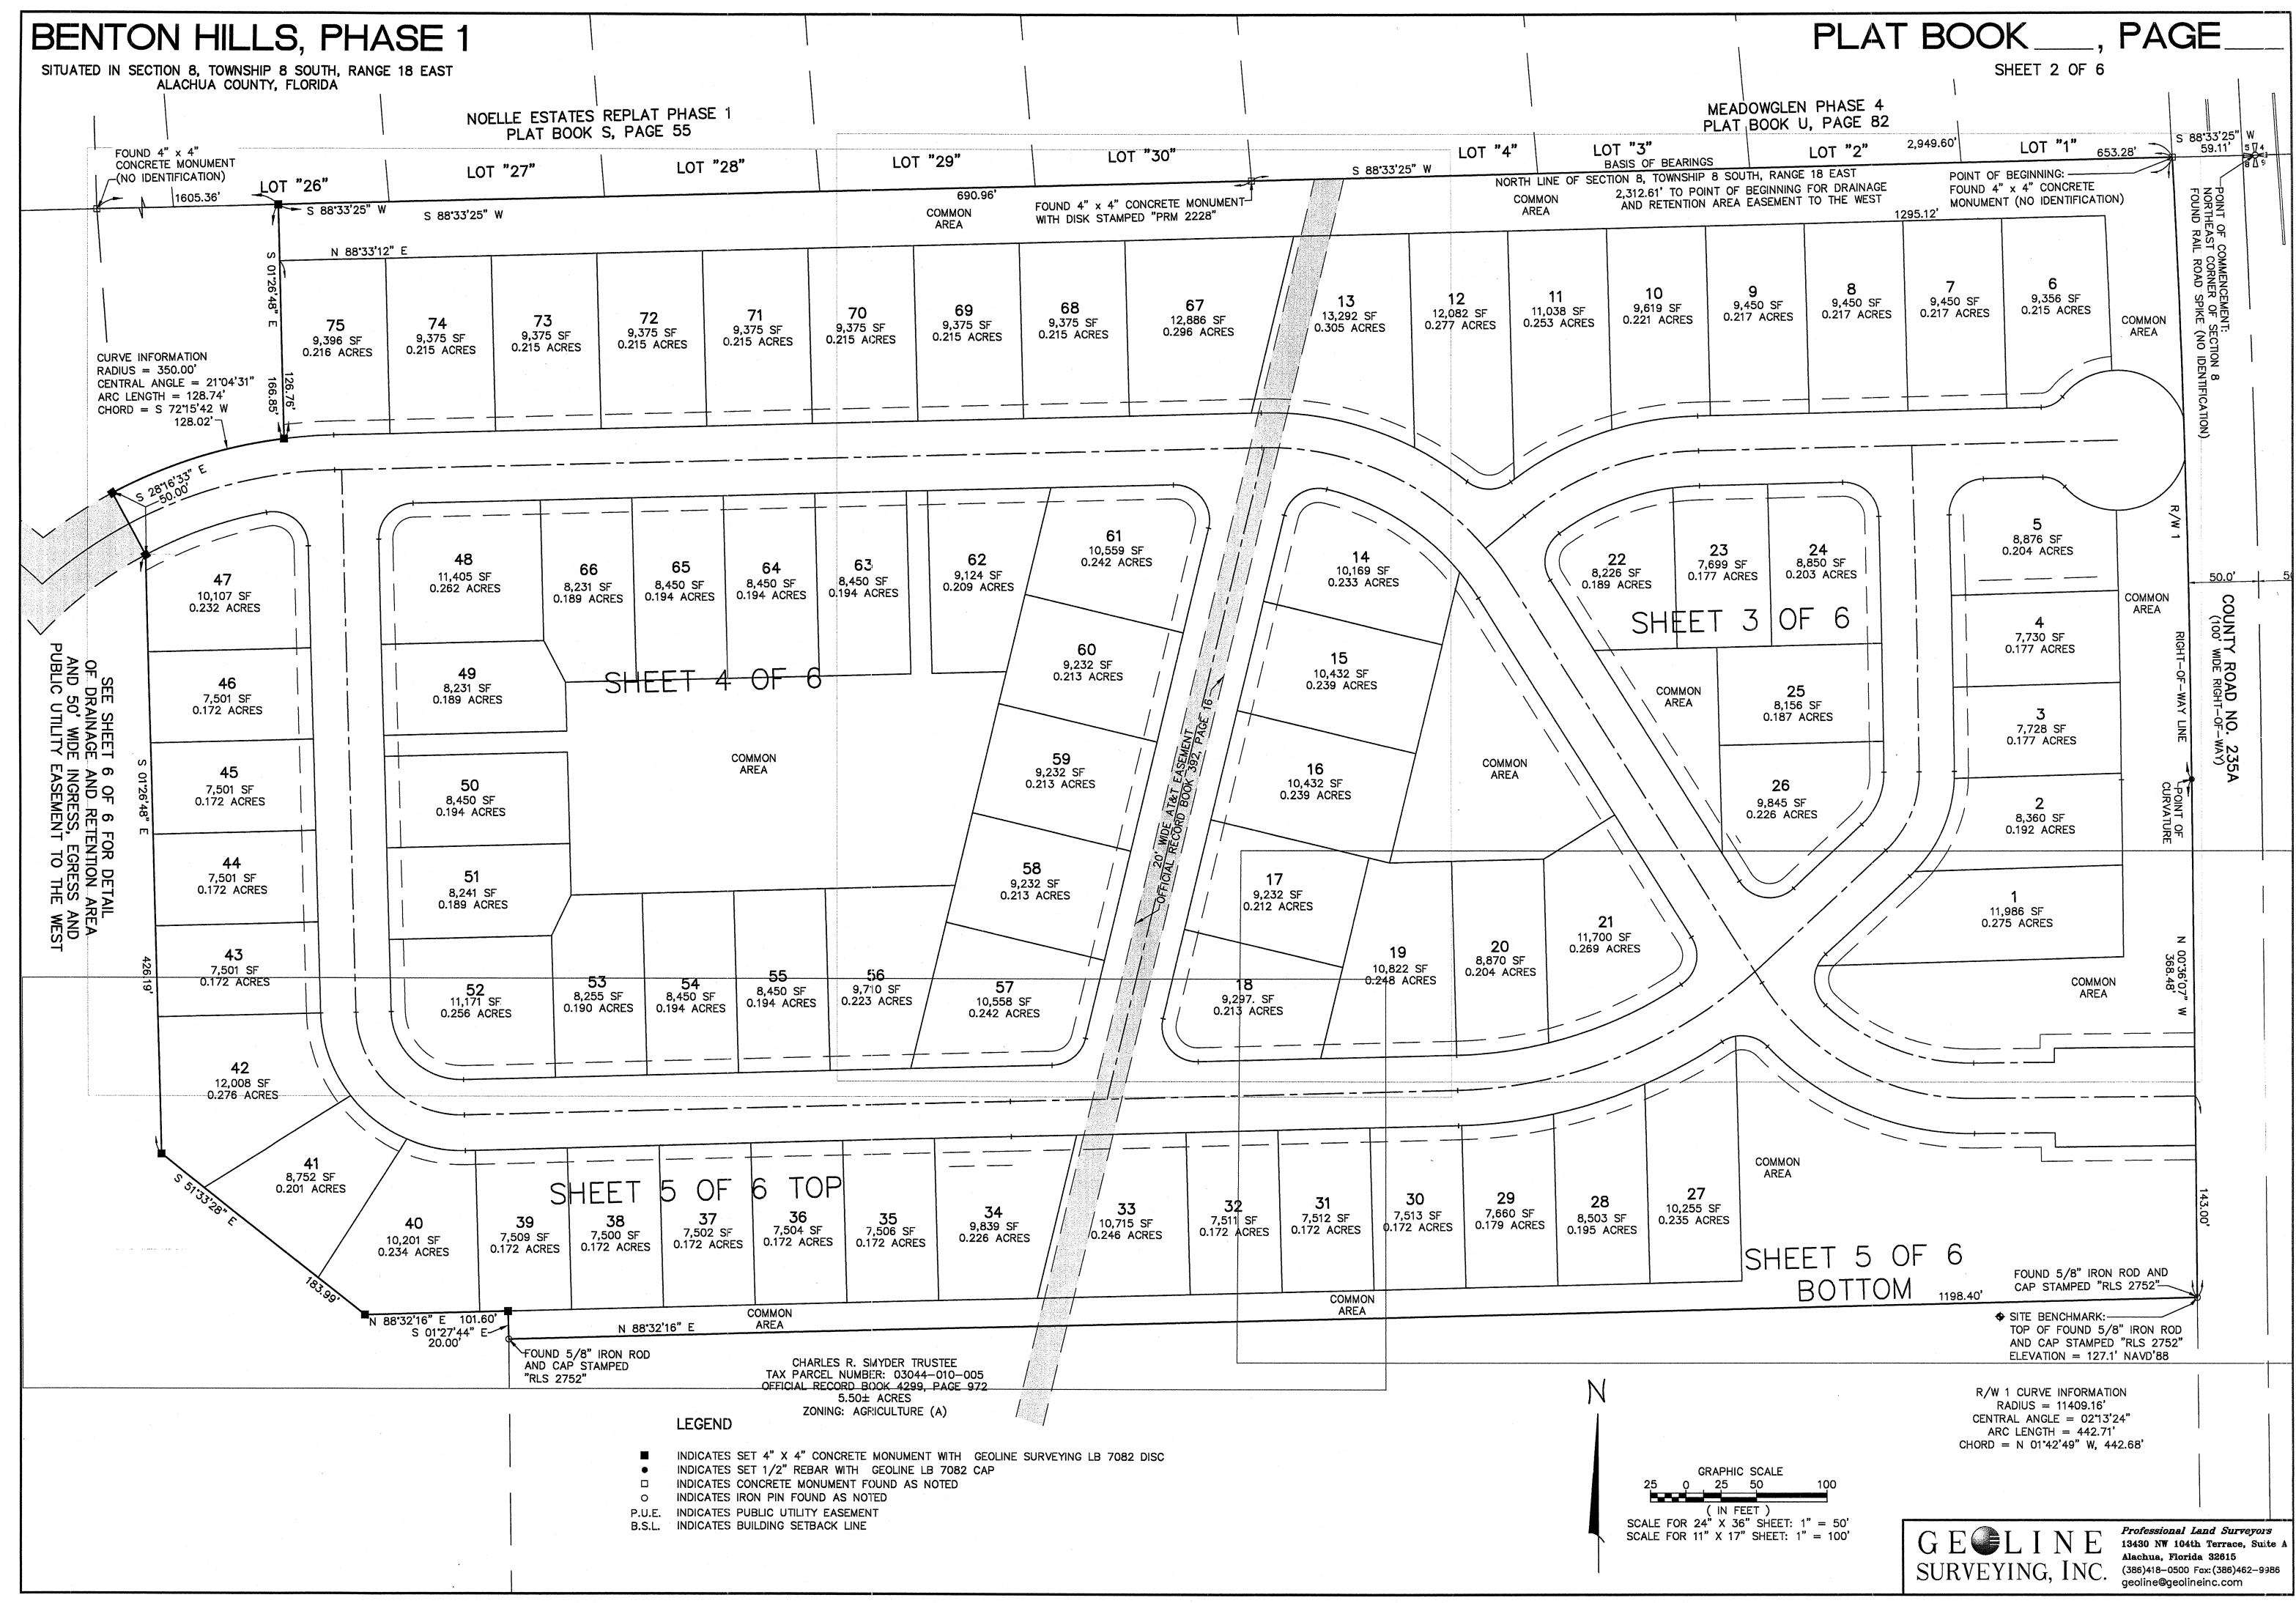
KNOW ALL MEN BY THESE PRESENTS, THAT. THE UNDERSIGNED, BEING A LICENSED AND REGISTERED LAND SURVEYOR, AS PROVIDED UNDER CHAPTER 472, FLORIDA STATUTES AND IS IN GOOD STANDING WITH THE BOARD OF LAND SURVEYORS, DOES HEREBY CERTIFY THAT ON MARCH 14, 2015 HE COMPLETED THE SURVEY OF THE LANDS AS SHOWN IN THE FOREGOING PLAT OR PLAN; THAT SAID PLAT IS A CORRECT. REPRESENTATION OF THE LANDS THEREIN DESCRIBED AND PLATTED OR SUBDIVIDED; THAT PERMANENT REFERENCE MONUMENTS HAVE BEEN PLACED AS SHOWN THEREON AS REQUIRED BY CHAPTER 177, FLORIDA STATUTES, AND THAT SAID IS SITUATED IN SECTION 8, TOWNSHIP 8 SOUTH, RANGE 18 EAST, CITY OF ALACHUA, ALACHUA COUNTY, FLORIDA. ALSO THIS PLAT WAS PREPARED UNDER MY DIRECTION AND SUPERVISION AND THAT THIS PLAT COMPLIES WITH ALL OF THE SURVEY REQUIREMENTS OF CHAPTER 177, PART I, FLORIDA STATUTES.

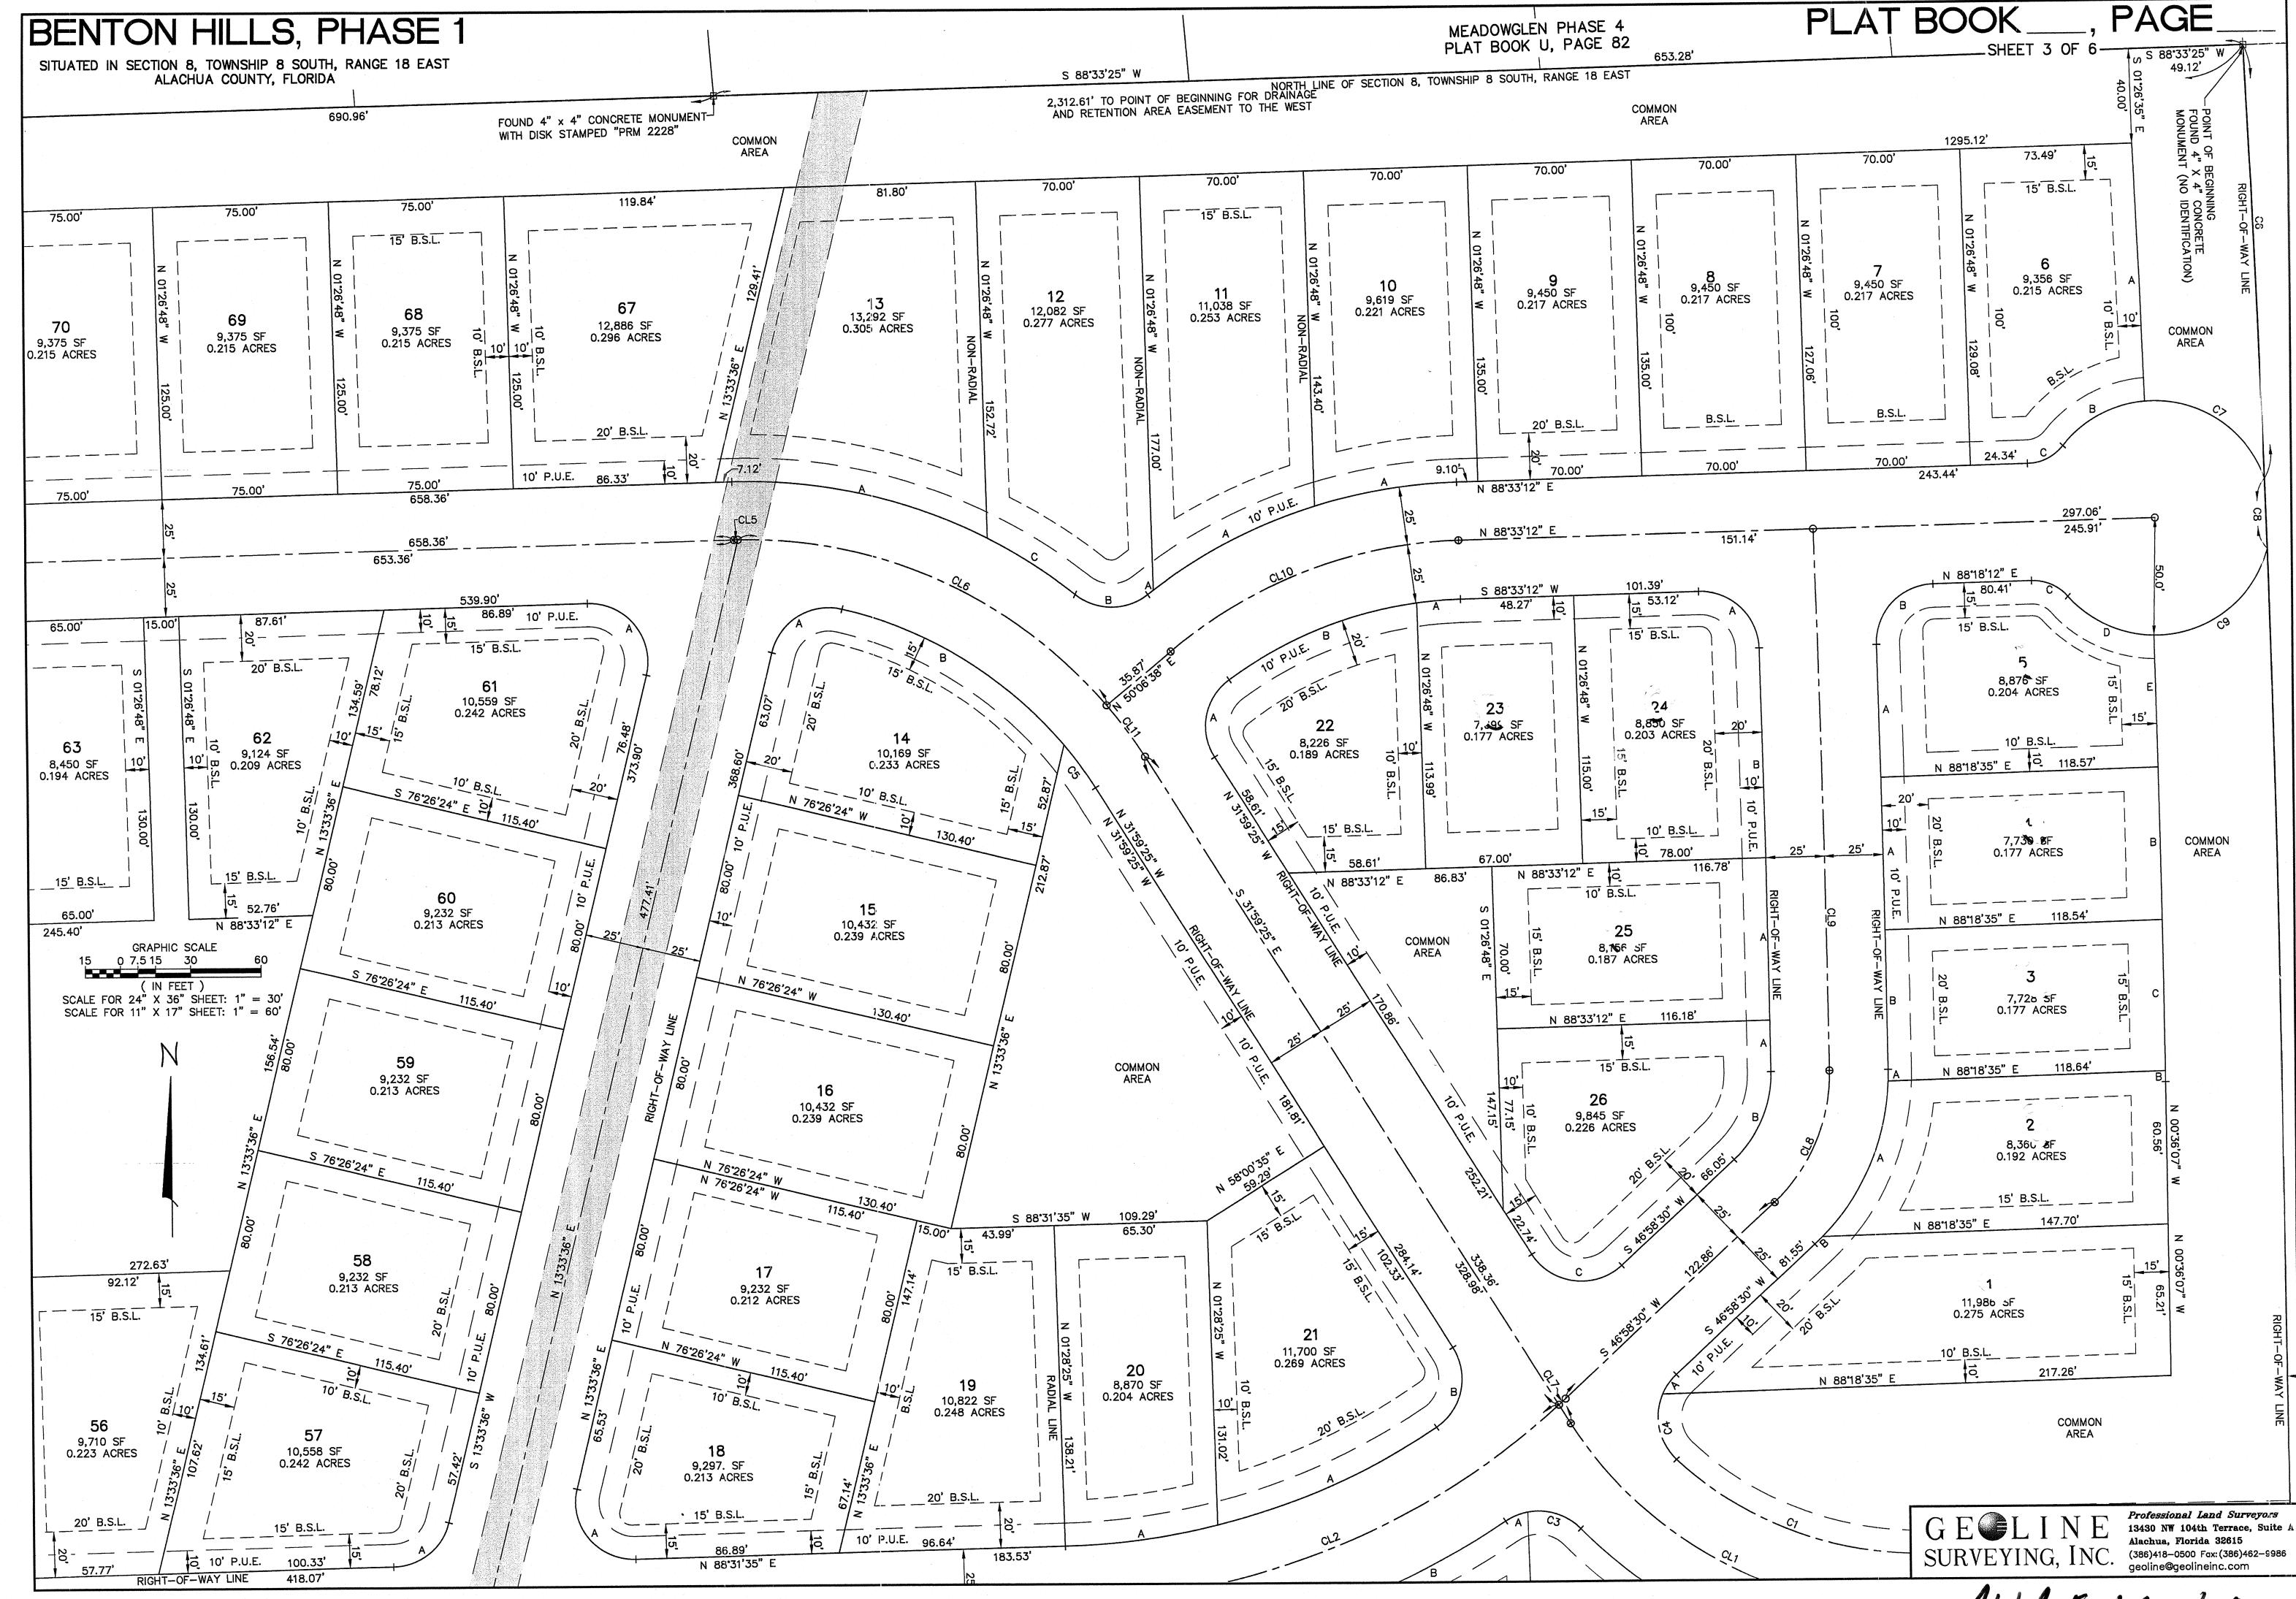
GEOLINE SURVEYING, INC., LB 7082

DAVID G. SHORT
FLORIDA PROFESSIONAL SURVEYOR AND MAPPER
CERTIFICATE OF REGISTRATION NO. 5022



Professional Land Surveyors
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