

VARIES PER
LAND DEVELOPMENT
REGULATIONS AND SHALL BE
DESIGNED CONSISTENT WITH
LDC ARTICLE 7 STANDARDS

TYPICAL CROSS SECTION - 50' RIGHT-OF-WAY

N.T.S.

- 1. SPECIFIC USES ALLOWED IN PD. LAND USES SHALL BE GENERALLY LOCATED AS SHOWN ON THE PD MASTER PLAN. THE FOLLOWING USES ARE ALLOWED IN THE "COMMON AREA/STORMWATER/OPEN SPACE AREA": ACTIVE & PASSIVE USE AREAS (TRAILS, PARKS, PLAYGROUNDS, CLUBHOUSE & POOL, ETC.), LANDSCAPED AREAS, UTILITY EASEMENTS AND STORMWATER MANAGEMENT FACILITIES. SINGLE FAMILY DETACHED PLATTED DWELLINGS ARE ALLOWED WITHIN THE "LOT DEVELOPMENT AREA." THE MINIMUM LOT SIZE FOR ANY PROPOSED LOT ALONG THE PROJECT PERIMETER ABUTTING (PARCEL NUMBERS 3042-50, 3875, 3876-100) LAND WITH AGRICULTURE OR RESIDENTIAL ZONING WILL BE \(\frac{1}{2} \) ACRE. ALSO, A 10-FOOT WIDE (MINIMUM) "TYPE C" LANDSCAPE BUFFER SHALL BE PROVIDED ALONG THE COMMON PROPERTY LINE WITH PARCELS 3046-1 AND 3046-2 AND MINIMUM LOT SIZE FOR LOTS ABUTTING THESE PARCELS WILL BE \(\frac{1}{3} \) ACRE.
- 2. PHASING. THE DEVELOPMENT SHALL CONSIST OF UP TO 5 PHASES OVER A MAXIMUM OF 10 YEARS, WITH THE FIRST PHASE PRELIMINARY PLAT SUBMITTED TO THE CITY WITHIN 12 MONTHS OF PD-R ZONING APPROVAL. THE LOCATION OF EACH PHASE SHALL BE DESIGNED IN A MANNER THAT WILL CREATE A LOGICAL AND FUNCTIONAL DEVELOPMENT AND INFRASTRUCTURE PATTERN. SPECIFICALLY, PHASING SHALL GENERALLY OCCUR FROM NORTH TO SOUTH WITH BOUNDARIES FOR EACH PHASE DETERMINED BY ACCESS AND UTILITY INFRASTRUCTURE
- 3. LOT SETBACK AND SEPARATIONS. HOUSING UNITS AND DESIGN SHALL AT A MINIMUM MEET THE REQUIREMENT OF THE FLORIDA BUILDING CODE.
 THE APPLICABLE SETBACKS ARE DEFINED ON THE PD MASTER PLAN.
- 4. OPEN SPACE. OPEN SPACE, AS DEFINED BY APPLICABLE SECTIONS OF THE LAND DEVELOPMENT REGULATIONS (LDRS) AND THE PD MASTER PLAN SHALL ACCOUNT FOR A MINIMUM OF 10% OF THE COMPLETED PROJECT AND THE GENERAL LOCATIONS ARE IDENTIFIED ON THE PD MASTER PLAN. THESE AREAS MAY CONTAIN LOW-INTENSITIVE PASSIVE OR ACTIVE RECREATION OPPORTUNITIES THROUGHOUT THE OPEN SPACE AREAS, INCLUDING NATURE TRAILS, PATHS, SIDEWALKS, AND NATURAL AREAS. MORE ACTIVE RECREATION USES SUCH AS PLAYGROUNDS, PICNIC AREAS, PAVILIONS & GAZEBOS ARE ONLY PERMITTED IN OPEN SPACE AREAS THAT IS LOCATED IN THE CENTER/INTERIOR OF THE PROJECT. AMENITY CENTER AND ANY ASSOCIATED PARKING OR OUTDOOR COMPONENT SHALL BE SETBACK FROM NW 188TH STREET RIGHT—OF—WAY A MINIMUM OF 250'.
- 5. CIRCULATION. THE CIRCULATION CONFIGURATION IS IDENTIFIED ON THE PD MASTER PLAN AND IS NOT INTENDED TO BE EXACT AND MAY BE AMENDED AS PERMITTED WITHIN THE CITY LDR. ROADWAYS INTENDED TO BE DEDICATED TO THE PUBLIC MAY BE CONSISTENT WITH THE TYPICAL SECTION WITHIN THE MASTER PLAN AND SHALL BE REQUIRED TO MEET THE APPLICABLE LDR DESIGN CRITERIA, UNLESS OTHERWISE AUTHORIZED BY THE CITY COMMISSION THROUGH LDR SEC. 3.6.3(A)(5)(B)(III). THE INTERNAL ROADWAYS SHOWN ON THE PD MASTER PLAN ARE INTENDED TO BE NEIGHBORHOOD STREETS AND DO NOT MEET THE ARTERIAL OR COLLECTOR ROADWAY DEFINITION.
- 6. LANDOWNER/DEVELOPER RESPONSIBILITY. THE LANDOWNER AND/OR DEVELOPER IS RESPONSIBLE FOR PROVIDING RIGHT-OF-WAY AND EASEMENTS FOR CONSTRUCTING ON-SITE INFRASTRUCTURE LOCATED IN THE PROPOSED PD-R DISTRICT, INCLUDING BUT NOT LIMITED TO ELECTRICAL UTILITY LINE, TELEPHONE LINES, CABLE TV LINES, OR THE UNDERGROUND CONDUIT FOR SUCH FEATURES. THE LANDOWNER/DEVELOPER IS RESPONSIBLE FOR PROVIDING AREAS FOR PUBLIC INFRASTRUCTURE AS REQUIRED BY CITY ORDINANCES, TO GUARANTEE CONSTRUCTION OF REQUIRED INFRASTRUCTURE, AND IF REQUESTED BY THE CITY, TO DEDICATE THESE IMPROVEMENTS TO THE CITY IN A FORM THAT COMPLIES WITH CITY REGULATIONS. ALL FACILITIES NOT DEDICATED TO THE CITY SHALL BE OPERATED AND MAINTAINED BY A PROPERTY OWNERS ASSOCIATION FORMED AS PART OF THE SUBDIVISION PROCESS.
- 7. ALLOWABLE LAND USE CLASSIFICATION DATA. FIGURES FOR ACREAGE ARE ESTIMATES AND HAVE BEEN ROUNDED TO THE NEAREST TENTH OF AN ACRE AND MAY BE SLIGHTLY ADJUSTED.
- 8. BLOCK FACES. ANY BLOCK FACES GREATER THAN 600' IN LENGTH SHALL INCLUDE A MINIMUM 10'-WIDE EASEMENT FOR PEDESTRIAN WAY THROUGH THE BLOCK (TO BE IMPROVED WITH CONCRETE, BRICK, PAVERS OR SIMILAR), CONSISTENT WITH LDR SEC. 7.2.3(B)(2) AND SEC. 3.6.3(A)(5)(B)(III) TO ENHANCE PEDESTRIAN CIRCULATION. TRAFFIC CALMING MEASURES THAT MAY BE USED TO CONNECT THESE MID-BLOCK CUTS WITH EACH OTHER OR OTHER ELEMENTS OF THE PEDESTRIAN CIRCULATION NETWORK, INCLUDE RAISED PEDESTRIAN CROSSINGS, CHANGE IN MATERIALS, BULB-OUTS, ETC. THESE PEDESTRIAN WAYS SHALL BE PRIVATLEY MAINTAINED, UNLESS A SEPARATE UNDERSTANDING HAS BEEN REACHED WITH CITY OF ALACHUA PUBLIC SERVICES.
- 9. STORMWATER: THE PROJECT SHALL UTILIZE ON-SITE STORMWATER SYSTEMS THAT ARE DESIGNED AND PERMITTED BY THE CITY OF ALACHUA AND THE SUWANNEE RIVER WATER MANAGEMENT DISTRICT (SRWMD) PER ALL APPLICABLE STANDARDS.
- 10. USE SPECIFIC STANDARDS IN LDR SEC. 4.3.1(A)(4)(d) ARE APPLICABLE TO SINGLE FAMILY DETACHED DWELLINGS WITHIN THE PROJECT AREA.

 11. REGARDLESS OF OWNERSHIP OF MAINTENANCE OF STREETS, ALL SIDEWALKS, AND CROSSWALKS WILL MEET FOOT LATEST STANDARDS. AND CITY OF
- ALACHUA REGULATIONS.

 12. REGULATED TREES SHALL BE SURVEYED AND LOCATION IDENTIFIED DURING THE SUBDIVISION PLAT DESIGN PHASE IN ORDER TO PRESERVE EXISTING TREES TO THE GREATEST EXTENT POSSIBLE. THE PD SHALL ALLOW FOR FLEXIBILITY IN ROAD AND LOT CONFIGURATION IN ORDER TO PRESERVE
- ON-SITE CANOPY AREAS WHICH WILL ENHANCE THE PROJECT BY PROVIDING SHADED GREEN SPACES, ADJACENCY BUFFERS, ETC.

 13. ALTERNATE SIGNAGE PLAN: UNIQUE CONDITIONS EXIST REGARDING FRONTAGE OF THE PD-R LIMITS IN RELATION TO US 441 FRONTAGE. THE ENTRANCE POINT FOR THE PD-R IS THROUGH COMMERCIAL ZONED PROPERTY FROM US 441 TO THE PD-R ZONING BOUNDARY. AS SUCH, TO ALLOW FOR THE INTENT OF NEIGHBORHOOD IDENTIFICATION SIGNAGE TO BE PROVIDED WITH VISIBILITY TO THE PUBLIC, STANDARD PERMANENT SIGNAGE FOR RESIDENTIAL NEIGHBORHOODS ALLOWED PER LDC SEC. 6.5.4(A) MAY BE PLACED WITHIN THE FUTURE RIGHT OF WAY FROM US 441 TO THE PD-R BOUNDARY (TO BE CONSTRUCTED TO SERVE THE PD-R PROJECT) IN ORDER TO ALLOW FOR THE SIGNAGE TO BE VISIBLE ALONG THE US

HIGHWAY 441 ROAD FRONTAGE. LAND FOR THE PLACEMENT OF SIGNAGE ALONG US 441 IS UNDER COMMON OWNERSHIP AND IF SOLD IN THE

FUTURE, AN EASEMENT FOR SIGNAGE LOCATION SHALL BE PROVIDED.

14. NO CONSTRUCTION VEHICLES SHALL ACCESS THE SITE FROM NW 188TH STREET DURING DEVELOPMENT OF PROPERTY.

DEVELOPMENT STANDARDS (LOT DEVELOPMENT AREA)			
LOT AREA. MIN. (SF)	10,000 S.F.		
LOT WIDTH. MIN. (FT)	50 FT.		
SETBACKS:			
FRONT MIN. (FT)	20 FT.		
REAR, MIN. (FT)	15 FT.		
SIDE, MIN. (FT)	7.5 FT.		
BUILDING STANDARDS:			
BUILDING HEIGHT, MAX. (FT)	65 FT.		
LOT COVERAGE, MAX. (% OF LOT)	40%		
PARKING, MIN. OFF-STREET (SPACES PER UNIT)	2		

BUILDING SETBACKS AND DIMENSIONAL STANDARDS APPLY ONLY TO INDIVIDUAL PLATTED LOTS AND ALL BUILDING SEPARATION REQUIREMENTS SPECIFIED IN THE FLORIDA BUILDING CODE ARE APPLICABLE.

DENSITY CALCULATION PER AREA	DENSITY, MIN & MAX (UNITS)
10,000 S.F. (MIN) LOT AREA	175–240
Ac. (MIN) LOT AREA	10–15
Ac. (MIN) LOT AREA	15-20
TOTAL	200-275

LAND USE DATA				
HATOH DATTERN	LAND LICE AREA	AR	EA	
HATCH PATTERN	LAND USE AREA	(AC)	(%)	
	PROJECT LIMITS	155.5	100%	
	LOT DEVELOPMENT AREA	87.0	56%	
	COMMON AREA/ STORMWATER/ OPEN SPACE	48.8	31%	
	RIGHT-OF-WAY	19.7	13%	

4:1 OR FLATTER TO MATCH NATURAL GROUND

LAND USE AREAS ARE APPROXIMATE AND MAY BE ADJUSTED DURING THE SUBSEQUENT DEVELOPMENT REVIEW PHASES OF THE PROJECT. UTILITIES AND SITE INFRASTRUCTURE REQUIRED TO SERVE THE PROJECT SHALL BE ALLOWED IN ALL LAND USE AREAS.



HIGH SPRINGS CITY LIMITS

INDEX OF PLANS			
SHEET NUMBER	DRAWING TITLE		
P100	PD MASTER PLAN		
P200	UTILITY PLAN		
P210	NOTES AND TABLES		
P300	EXISTING CONDITIONS MAP		




CONSULTANTS INC.

EB 2389
720 S.W. 2nd Ave, South Tower, Suite 300

GAINESVILLE, FLORIDA 32601

TEL. (352) 373-3541

www.edafl.com mail@edafl.com

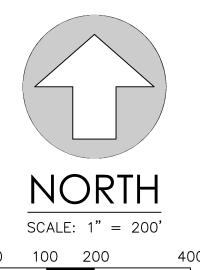

Date Comment

Project No: 21-176
Project phase:

ZONING
Project title:

NW 188TH STREET/ US 441
PLANNED DEVELOPMENT
CITY OF ALACHUA, FL


Sheet title:

PD MASTER PLAN

Designed: CBS Sheet No.:


Drawn: LBO P10

Date: 06/08/22

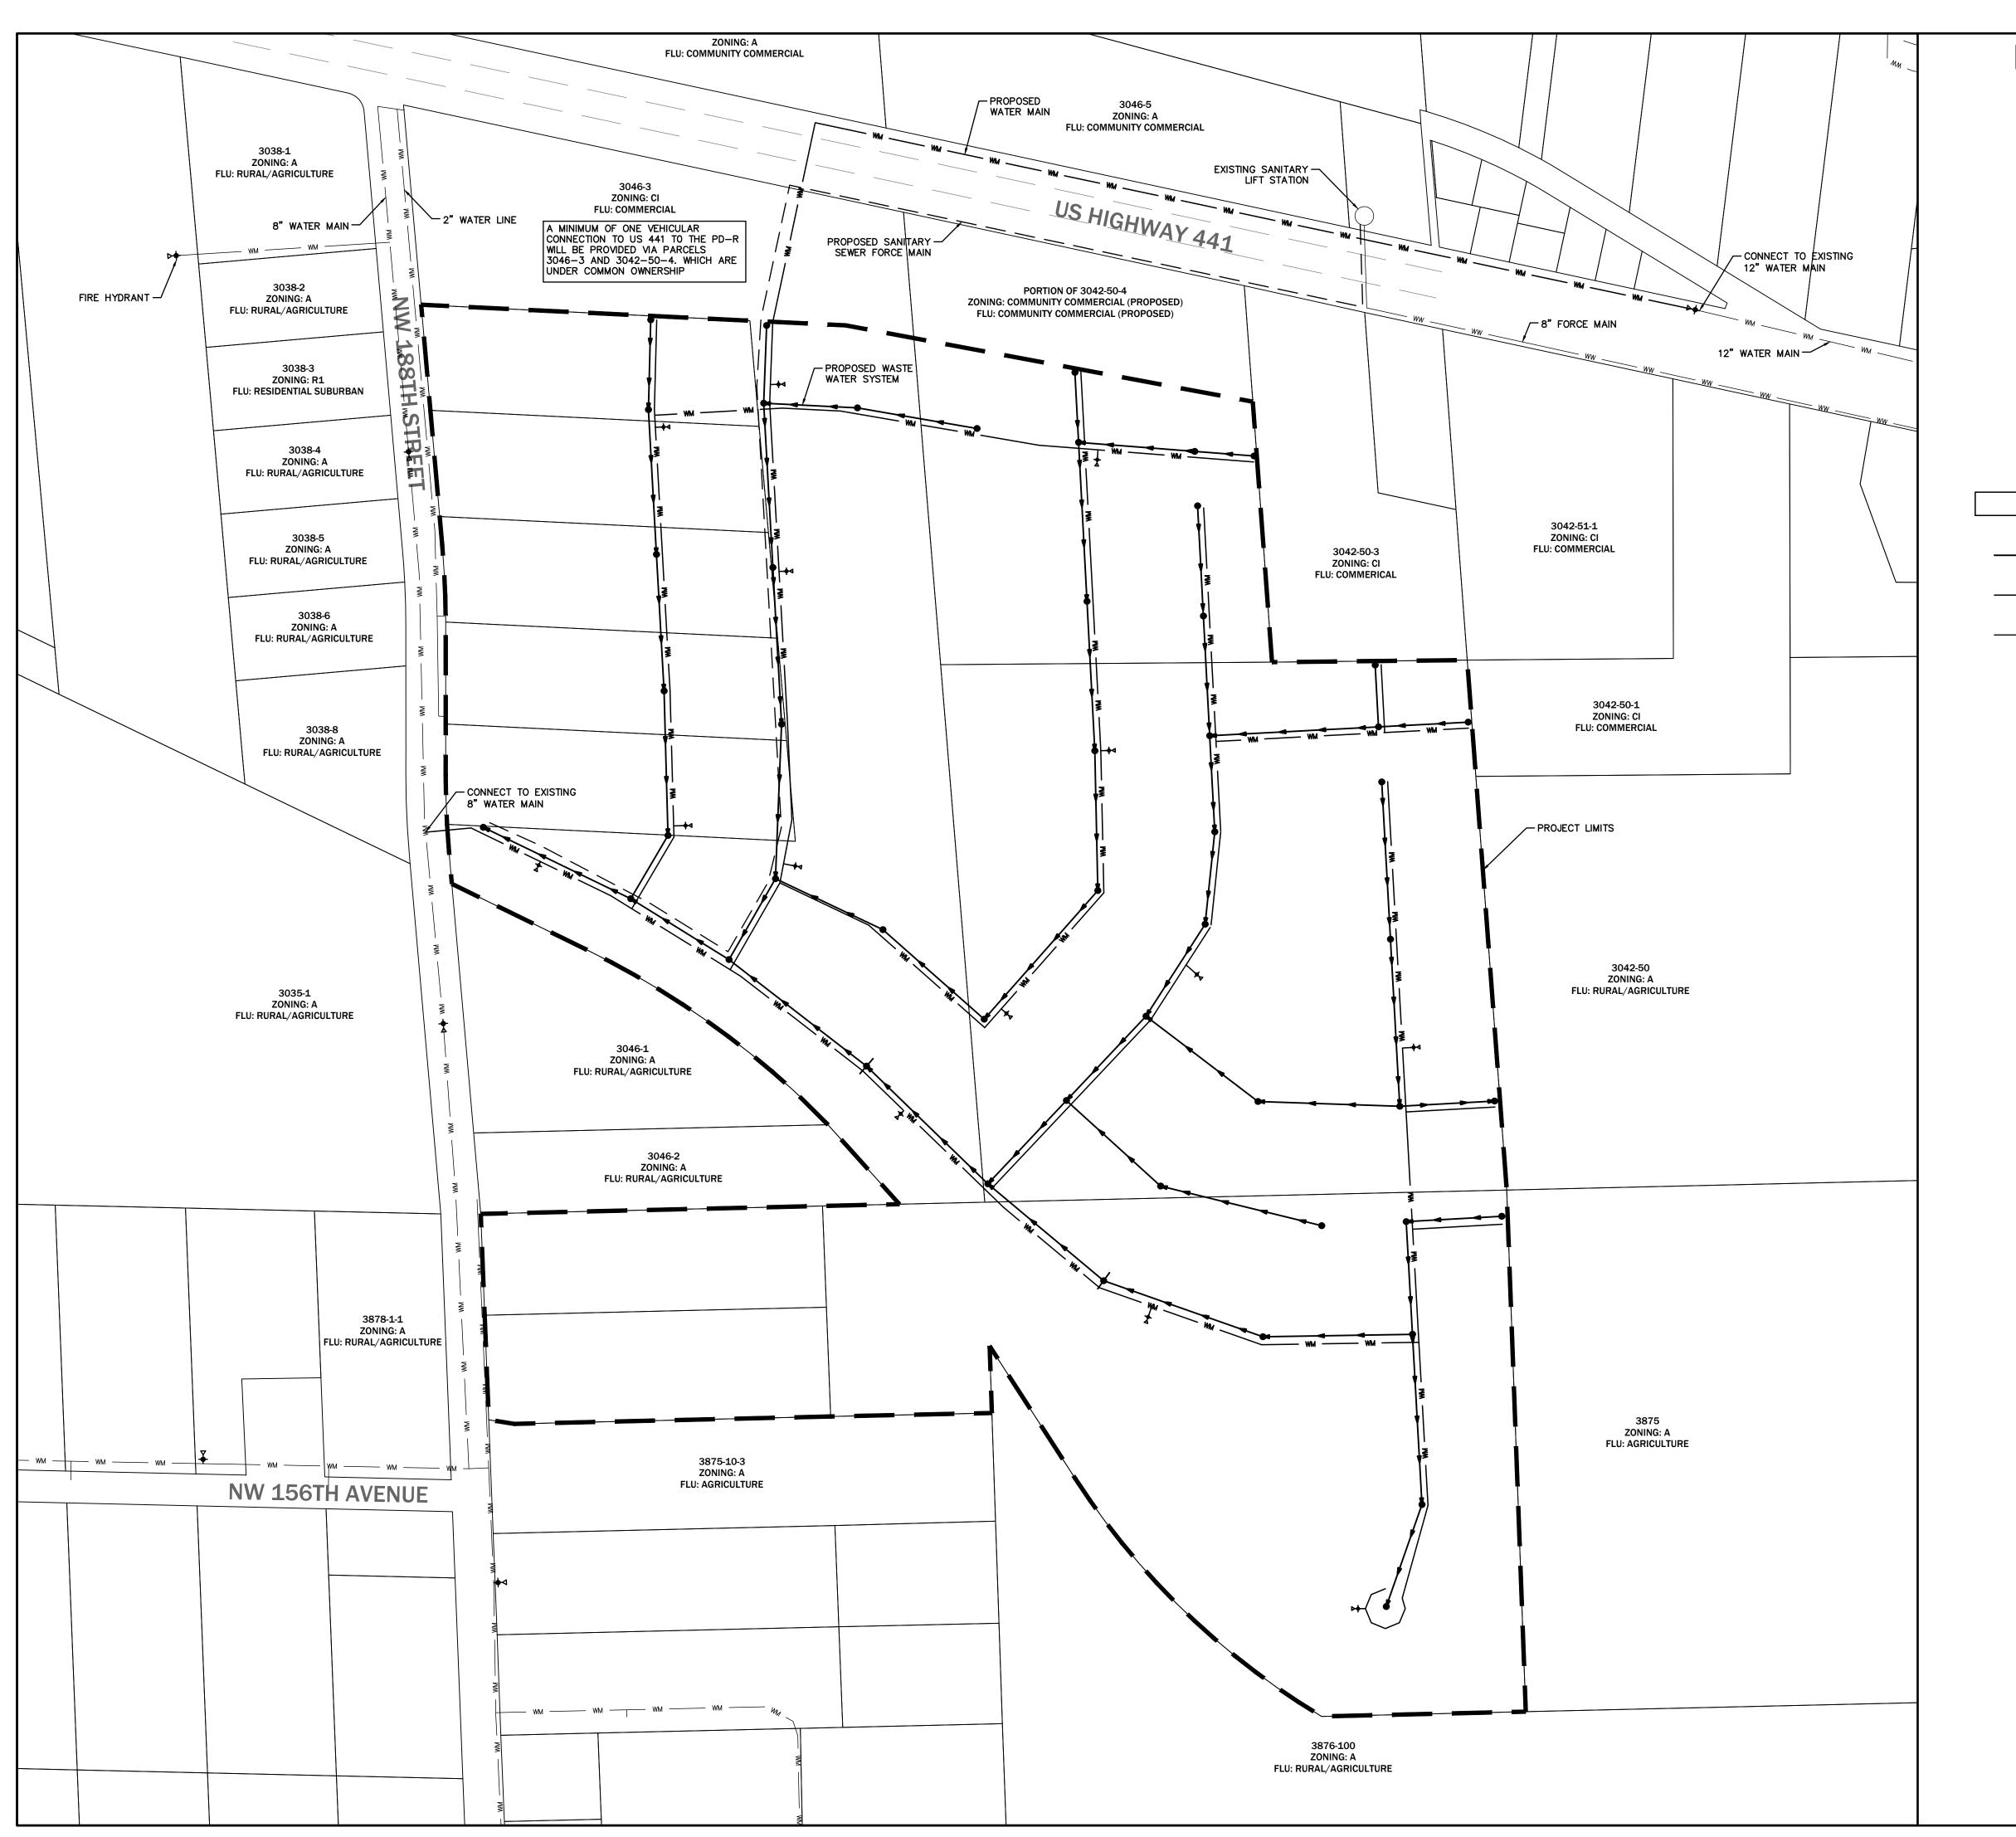

UTILITY PLAN GENERAL NOTES

- POTABLE WATER: AN 8-INCH POTABLE WATER MAIN RUNS ALONG THE NW 188TH STREET RIGHT-OF-WAY. DIRECT CONNECTION IS ANTICIPATED.
- 2. SANITARY SEWER: AN 8-INCH SEWER FORCE MAIN AND LIFT STATION ARE LOCATED IMMEDIATELY NORTH EAST OF PROJECT SITE ALONG THE NORTH SIDE OF US HIGHWAY 441. CONNECTION TO THIS FACILITY IS PROPOSED.
- 3. STORMWATER MANAGEMENT FACILITIES: STORMWATER MANAGEMENT SHALL BE LOCATED ON—SITE AND SHALL BE DESIGNED AND PERMITTED WITH THE CITY OF ALACHUA AND THE SUWANNEE RIVER WATER MANAGEMENT DISTRICT ACCORDING TO ALL APPLICABLE STANDARDS
- 4. PUBLIC FACILITIES IMPACT: CONCURRENCY RESERVATION WILL BE MADE AT TIME OF FINAL PD APPROVAL. PROJECT CALCULATIONS ARE PROVIDED IN THE PD JUSTIFICATION REPORT AS INDICATED BELOW TO DEMONSTRATE THAT SUFFICIENT CAPACITY EXISTS TO ACCOMMODATE THE PROPOSED PROJECT.
- 5. SEE SHEET P210 FOR ROADWAYS AND & TRANSPORTATION NOTES
- 6. LOCATION OF ALL PROPOSED UTILITIES ARE CONCEPTUAL AND MAY BE ADJUSTED AS PART OF THE FULL ENGINEERING DESIGN OF THE PROJECT, INCLUDING LIFT STATION LOCATION, WHICH WILL BE DETERMINED AT THE TIME OF FINAL DESIGN AND BE COORDINATED WITH CITY OF ALACHUA PUBLIC SERVICES DEPARTMENT FOR MOST APPROPRIATE LOCATION BASED ON SITE CONDITIONS.

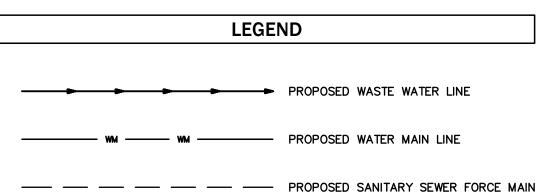

▶ PROPOSED FIRE HYDRANT

PROPOSED MAN HOLE



EB 2389
720 S.W. 2nd Ave, South Tower, Suite 300
GAINESVILLE, FLORIDA 32601
TEL. [352] 373-3541
www.edafl.com mail@edafl.com

NORTH

SCALE: 1" = 200'

0 100 200

GRAPHIC SCALE

o. Date Comment

Project No:
21-176
Project phase:

ZONING
Project title:

NW 188TH STREET/ US 441
PLANNED DEVELOPMENT
CITY OF ALACHUA, FL

Sheet title:

Designed: CBS Sheet No.:

UTILITY PLAN

Drawn: LB0
Checked: TAR

Date: 04/07/22

3\engprojects\Lerner Properties - Alachua - 2021-0176\Plans\Current DWG\PD PLAN\L21176PD1.dwg, NOTES AND TABLES, 2/16/2022 3:14:14 PM, TAR, _DWG To PDF.

ROADWAYS & TRANSPORTATION

The affected roadways are Segments 7 and 6, which are the segments with a projected impact over 5% of the total Maximum Service Volume (MSV). The tables below indicate that the affected roadway segments will continue to retain sufficient roadway capacity during both AADT and PM PEAK and therefore will not negatively affect the adopted Level of Service (LOS).

MAXIMUM PD DEVELOPMENT SCENARIO – AM & PM PEAK

ITE CODE	UNITS	DESCRIPTION	RATE	DAILY TRIPS (ADT)
210	275	Single Family	9.44 / Unit	2,596
ITE CODE	UNITS	DESCRIPTION	RATE	PM PEAK HOUR OF ADJACENT STREET TRAFF
210	275	Single Family	1.0 / Unit	275

Affected Roadway Segments (Above 5% MSV)

- US 441 Segment 7 (From 235A to NW 188th Street)
- US 441 Segment 6 (From I-75 to CR 235A)

Trip Distribution on Affected Roadway Segments

- 100% Distribution on US 441 Segment 7 (2,596 ADT, 275 PM Peak)
- 70% East (1,817 ADT, 193 PM PEAK) / 30% West (779 ADT, 82 PM PEAK)
 55% Distribution (of 1,817 ADT) on US 441 Segment 6 (1,000 ADT, 106 PM Peak)

Level of Service Analysis / Affected Roadway Segments (ADT)

Traffic System Category	US 441 Segment 7		
Maximum Service Volume	43,000		
Existing Traffic and Reserved Trips	23,815		
Project Trips (ADT)	2,596		
Available Capacity	16,589		

Level of Service Analysis / Affected Roadway Segments (PM PEAK)

Traffic System Category	US 441 Segment 7		
Maximum Service Volume	3,870		
Existing Traffic and Reserved Trips	2,243		
Project Trips (PM Peak)	275		
Available Capacity	1,352		

Level of Service Analysis / Affected Roadway Segments (ADT)

Traffic System Category	US 441 Segment 6		
Maximum Service Volume	39,000		
Existing Traffic and Reserved	32,038		
Trips			
Project Trips (ADT)	1,000		
Available Capacity	5,962		

Level of Service Analysis / Affected Roadway Segments (PM PEAK) Traffic System Category IIS 441 Segment 6

Traffic System Category	US 441 Segment 6		
Maximum Service Volume	3,510		
Existing Traffic and Reserved 3,015			
Trips			
Project Trips (PM Peak)	106		
Available Capacity	389		

Sanitary Sewer:

The following analysis examines public facilities impacts to City wastewater facilities. For the proposed residential uses, the flow rates were calculated using the ratio of 250 GPD / unit. Residential calculations using a maximum development scenario, an increase of 68,750 GPD may occur. Adequate capacity is available to support this development and will not negatively impact the City's adopted LOS for this system.

Sanitary Sewer Impacts				
System Category	<u>GPD</u>			
Treatment Plan Current Permitted Capacity	1,500,000			
Less Actual Treatment Plant Flows	677,000			
Reserved Capacity	180,101			
Parcel Demand for Site	68,750			
Residual Capacity	574,149			

^{1.} Source: City of Alachua Public Services Department, January 2022

Potable Water:

The following analysis examines public facilities impacts to the City potable water system. Residential calculations using a maximum development scenario, an increase of 75,625 GPD may occur. Adequate capacity is available to support this development and will not negatively impact the City's adopted LOS for this system.

Potable Water Impacts

System Category	<u>GPD</u>		
Current Permitted Capacity	2,300,000		
Less Actual Potable Water Flows	1,300,250		
Reserved Capacity ²	200,907		
Parcel Demand for Site	75,625		
Residual Capacity	723,218		

1. Source: City of Alachua Public Services Department, January 2022

Solid Waste:

Maximum Development Scenario Project Impact: Residential uses generate approximately 0.73 tons per year of solid waste per capita per City of Alachua Comprehensive Plan (275 units x 2.3 residents per unit x 0.73 tons/year per capita = 461 tons).

The following table indicates the projected solid waste generation, which will not exceed the City's overall Level of Service standards:

Solid Waste Impact

Solid Waste Impact – Residential Land Uses¹ 461 Tons

1. Formula: (0.73 tons / year per capita @ 2.3 residents per unit)

PUBLIC SCHOOLS

Impacts from the proposed PD-R zoning area on public school facilities adopted Level of Service are summarized below:

# of Elementary School # of Middle School # of High School Student Generation	Student Station Student Station	s = s =	#	of housing units of housing units of housing units amily Residentia	x Middle school student ge x High school student gene	neration r	nultiplier [*]
Elementary School	275	units	X	0.14	Elementary School Multiplier*	39	Student Stations**
Middle School	275	units	X	0.06	Middle School Multiplier*	17	Student Stations**
High School	275	units	v	0.08	High School Multiplier*	22	Student Stations*

Approval of the application will result in a projected school enrollment impact of 39 elementary, 17 middle and 22 high school student stations.

RECREATION

Recreation Impact Table

Necleation impact rable	
System Category	Acreage
Existing City of Alachua Recreation Acreage	135.48
Acreage Required to Serve Existing Population	52.35
Reserved Capacity	2.20
Project Demand (PD-R Zoning Area)	3.8
Available Recreation Acreage	77.13

- 1. Source: City of Alachua Public Services Department, January 2022
- 2. Calculations for Proposed Project: 275 Units x 2.76 persons/household x 5 acres / 1,000 persons = 3.8 acres

As indicated in the table above, the City of Alachua currently has sizable excess acreage for local recreation activities. In addition, the proposed PD will have open space area set aside for recreational facilities for the residents of the development. As such, the intended residential development is expected to have a minimal impact on the City's current recreational infrastructure.

FIRE / EMS

The proposed development will be served by Fire Station #21 located at 15040 NW US 441.

POLICE

The proposed development will be served by the City of Alachua Police Department located at 15000 NW 142nd Avenue.



No.	Date	Comment

oject	No:		
_		21-176	
oject	phase:		
		ZONING	

NW 188TH STREET/ US 441
PLANNED DEVELOPMENT
CITY OF ALACHUA, FL

Sheet title:

Project title:

NOTES AND TABLES

Designed:	CBS	Sheet No.:
Drawn:	LBO	
Checked:	TAR] P'∠
Date: 02,	/16/22	

P210




EXISTING CONDITIONS PLAN GENERAL NOTES

1. BASED ON AVAILABLE INFORMATION AND KNOWLEDGE OF THE PROPERTY, THERE ARE NO KNOWN REGULATED NATURAL RESOURCES ON THE SUBJECT PROPERTY. A PORTION OF THE PROPERTY IS CURRENTLY DEPOSITE OF THE PROPERTY AND THE REMAINDER AS TIMBER LAND (PLANTED PINES).



EB 2389 720 S.W. 2nd Ave, South Tower, Suite 300 GAINESVILLE, FLORIDA 32601 TEL. (352) 373-3541 www.edafl.com mail@edafl.com

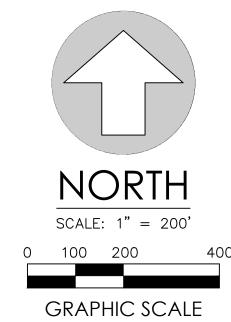

No.	Date	Comment

21-176 Project phase:

ZONING Project title:

NW 188TH STREET/ US 441 PLANNED DEVELOPMENT CITY OF ALACHUA, FL

EXISTING CONDITIONS MAP

esigned:	CBS	Sheet N
rawn:	LBO	╽╶
hecked:	TAR] F

P300 Date: 02/16/22