

THE GOOD LIFE COMMUNITY

FOR PLANNING USE ONLY Case #:	
Application Fee: \$ Filing Date:	
Acceptance Date: Review Type: P&Z	

# Certificate of Appropriateness Application

Reference City of Alachua Land Development Regulations 2.4.6

You must have all information for your application to be considered complete. Incomplete applications will not be accepted.

A.	PF	ROJECT TYPE
		Demolition □ Removal
	M	New Construction ☐ Addition
	7	Alteration of Exterior Features
В.	AF	PPLICANT
	1.	Applicant's Status    Owner (title holder)    Agent
	2.	Name of Applicant(s) or Contact Person(s): Lersy Hanes Title: Dwn ER
		Company (if applicable):
		Physical address: 14720 Main Street
		Mailing Address: 14720 Main Street
		City: Alachsa State: FC ZIP: 32615
	3.	If the applicant is agent for the property owner*:
		Name of Owner (title holder):
		Mailing Address:
		City: State: ZIP:
		Telephone: FAX:e-mail:
<b>)</b> .	PR	OPERTY AFFECTED
	1.	Address of Subject Property: 14720 Main Street
	2.	
	3.	Existing Use of Property: Single Family
	4.	Future Land Use Map Designation:
	5.	Zoning Designation: CBP
	6.	Acreage:
	7.	Number of Existing Structures on the Property:
).	AT	TACHMENTS
	1.	A detailed drawing which identifies the dimensions of the property, location of existing building(s) and

## D

- those proposed (if applicable), distances of buildings from property lines, building setback lines (dimensioned), and names of adjacent streets. A current survey or site plan may be submitted to meet this requirement, if all requested information is provided.
- 2. Set of plans and specifications for the project. All drawings must be clear, concise, and drawn to scale. Plans must include and dimension all exterior elevations and provide a dimensioned floor plan illustrating all rooms within any proposed addition (if applicable).
- 3. Photographs of existing building(s) (all facades or elevations of building(s) and adjacent buildings). Photographs must clearly illustrate the appearance and conditions of existing building(s) affected by the project, close-up pictures of any specific elements under consideration by the project (for

example, windows or doors if proposed to be removed and/or replaced), as well as photographs depicting such elements and their relation with neighboring buildings.

- If demolition is proposed, a report from a registered structural engineer stating the condition of the structure.
- 5. The applicant must provide a report which addresses the following:

## (1) Affect Exterior Appearance

Whether the proposed action will affect the exterior appearance of the subject land or structure or the appearance of any interior portion specifically identified in any relevant designation ordinance.

## (2) Affect Consistent with Historical, Architectural, or Other Relevant Qualities

Whether any such affect is consistent with the historical, architectural, or other qualities which the relevant designation ordinance seeks to protect and enforce.

## (3) Negative or Positive Impact on Neighboring Lands of Historical Significance

Whether the proposed action will have a negative or positive impact on neighboring lands that have historic significance.

#### (4) Effect of Denial

Whether the denial of a Certificate of Appropriateness would deprive the owner of reasonable beneficial use of their land.

#### (5) Demolition

In cases where a Certificate of Appropriateness is proposed for demolition of all or a portion of a Historic Property, the applicant shall demonstrate:

- (a) That no other feasible alternative can be found;
- (b) The extent to which the land may not be beneficially used without approval of the demolition;
- (c) The ability to obtain a reasonable return from the existing structure(s); and
- (d) Whether or not the building, structure, or land contributes to a Historic Overlay (HO) District, or no longer has historical significance.
- 6. Proof of ownership.
- 7. Proof of payment of taxes.
- 8. Fee. Please see fee schedule for fee determination. No application shall be accepted for processing until the required application fee is paid in full by the applicant. Any necessary technical review will be billed to the applicant at the rate of the reviewing entity. The invoice shall be paid in full prior to any legislative and/or quasi-judicial action of any kind on the petition, appeal, or development application.

<u>All attachments are required for a complete application.</u> A completeness review of the application will be conducted within five (5) business days of receipt. If the application is determined to be incomplete, the application will be returned to the applicant.

## I/We certify and acknowledge that:

- 1. I We must comply with the current Florida Building Code through the Building Department and obtain any necessary permits prior to receiving a final certificate of occupancy.
- 2. I/We must comply with the requirements of the Alachua County Fire Marshall.

Bonded Thru Budget Notary Services

- 3. I We must obtain a Local Business Tax Receipt.
- 4. I/We must meet parking standards and any use specific standards for the zoning district
- Falsifying information on this application may result in the Certificate of Appropriateness being revoked.

Hill	Shoben Hones
Signature of Applicant	Signature of Co-applicant
Lerry Hones	Stoban Hanes
Typed or printed name and title of applicant	Typed or printed name of co-applicant
10/4/17	Oct 4, 2017
Date	Date /
	dalhua
The foregoing application is acknowledged before me this	day of Ct , 2017 by Letay theres
ibbea has a who is/are personally known to me,	or who has/have produced H DL
as identification.  NOTARY SEAL  ***  **  **  **  **  **  **  **  **	60

# Section 5 HANES CERTIFICATE OF APPROPRIATEESS APPLICATION

## 1. Affect Exterior Appearance:

This home was built in circa 1920 with an addition added in 2003. The location of the garage will be at the rear of the property on the back section of the half acre which is not visible from the public right of way. There are numerous metal buildings and structures in the area.

## 2. Affect Consistent with Historical, Architectural, or Other Relevant Qualities:

The garage is in line with the home and similar structures on adjacent properties and does not affect the historical or architectural qualities of homes in the district. The garage will not be visible from the public right of way, as it is in the rear portion of the ½ acre.

There are adjacent metal buildings in the area "See attached photos."

## 3. Negative or Positive Impact on Neighboring Lands of Historical Significance:

The construction of a garage will add a higher value to the property. There is no negative impact to the area.

### 4. Effect of Denial:


This is a mixed use commercial property in the Central Business District. This garage is located in the central business district and will be used for my art / woodworking studio. I make wood, metal and PVC art which we plan to sell in the commercial store in the front of the house. This directly impacts my income / quality of life.

#### 5. Demolition:

Proposing to remove: 7x8 (56sqft) plastic building, which is damaged and leaking from a tree limb taken out by the previous owners. 12x25 300sqft metal carport also damaged from tree limbs. 11.5x23.8 273.7sqft portable building which is also has a damaged roof from tree limbs

None of the existing structures have any Historical, Architectural or Other Relevant Qualities

Total floor area of existing structures to be removed is 626.7sqft Total floor area for the proposed structure is 840sqft

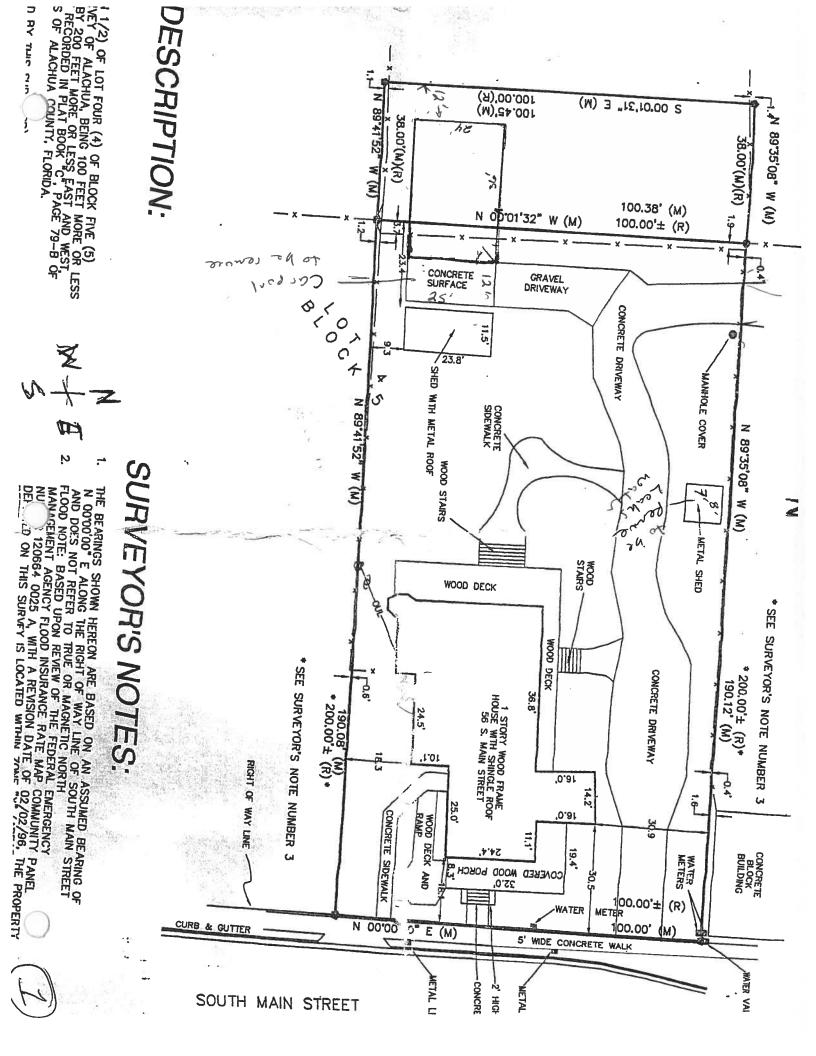

## City of Alachua

From: "Leroy Hanes" < lhanes0499@gmail.com>

To: Ahall@cityofalachua.com

Sent: Wednesday, September 27, 2017 4:42:35 PM

Subject: Hanes Certificate of Appropriateness Application

Hello Adam

Thanks so much for your time today.

I have changed the Section 5 statement and attached it along with the photos.

The upstairs has 3 sections
24 sqft 3x8 air conditioned space
20 sqft 4x5 air conditioned space
57 sqft 3x19 non-air-conditioned spaced

The attic space that is air conditioned is 9x22 or 198 Sqft

**Leroy Hanes** 

## **Zimbra**

## ad\_hall@cityofalachua.org

## Re: Hanes Certificate of Appropriateness Application

From: Leroy Hanes

Thu, Sep 28, 2017 01:53 PM

<lhanes0499@gmail.com</pre>

>

Subject: Re: Hanes Certificate of

**Appropriateness** 

**Application** 

To: Adam Hall

<ad\_hall@cityofalachua.or

g>

These areas

24 sqft 3x8 air conditioned space

20 sqft 4x5 air conditioned space

57 sqft 3x19 non-air-conditioned spaced

From: Adam Hall

Sent: Thursday, September 28, 2017 1:35 PM


**To:** Leroy Hanes


Subject: Re: Hanes Certificate of Appropriateness Application

Leroy:


How much of the finished upstairs area (either conditioned or unconditioned) has a ceiling height of 7' or greater?

Adam Hall

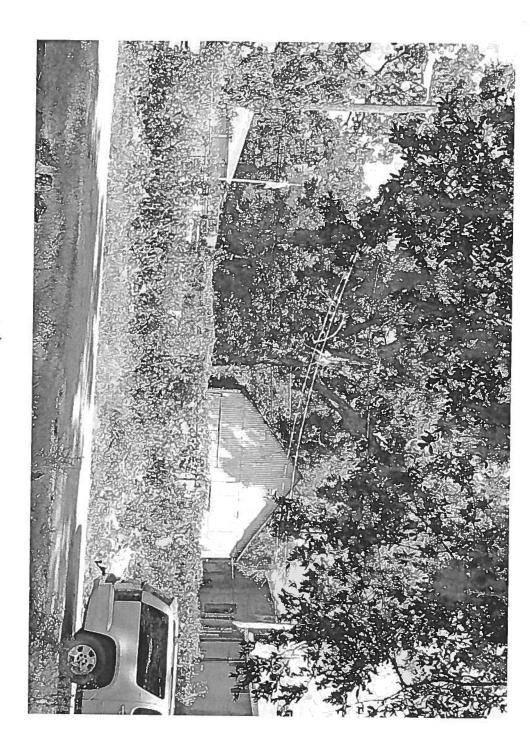

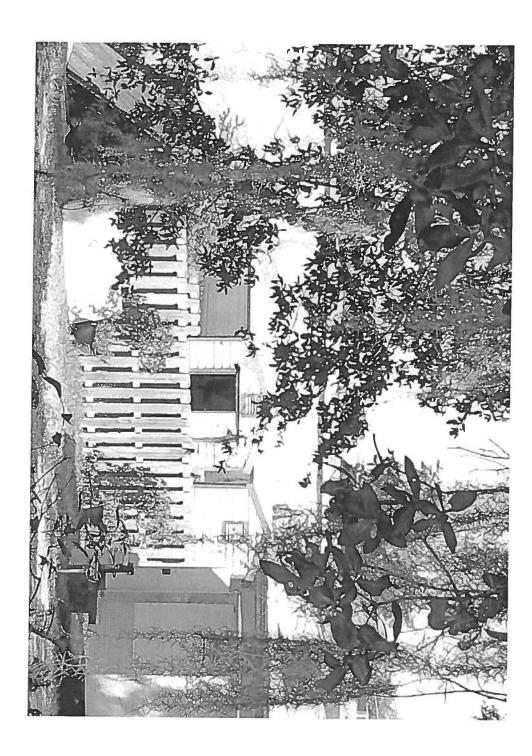


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TOLL FREE: 866-238-3501

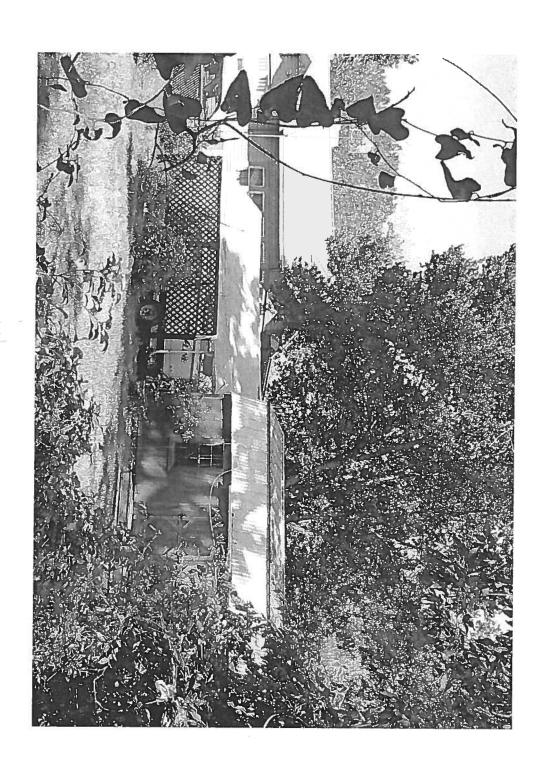Phone: 770-775-2254 Fax: 770-504-0235

Email orders to: orders@rbmetal.com

7/27/2017 Date Dealer # F-217 352-472-7100 Phone

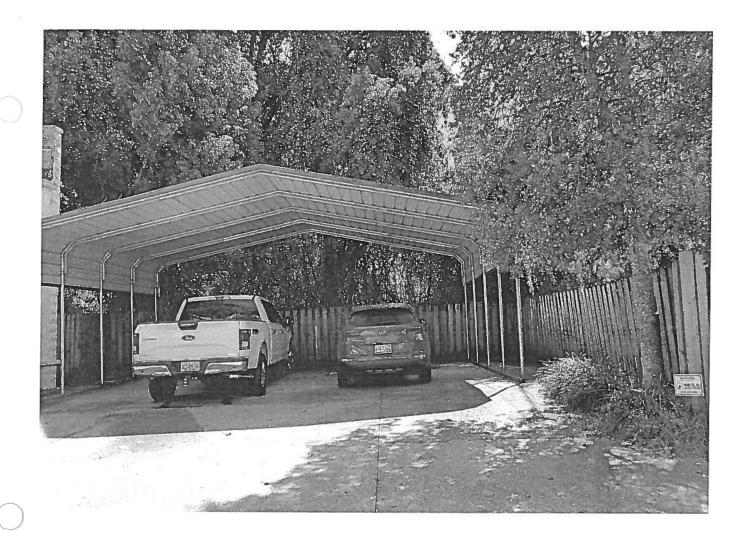Name	Lee Hanes			Phone(Day)		352-587-5407
elivery Addr	ess	14720	Main St	Cell		
				Email	-1	
City Alachua		State FL	Zip 32615	Building w		
County Alachi	ua			Trim Color U	uhile	
Building Width	Roof Length	Frame Length	Leg Height	Non- Certified	Traditional	Vertical Roof ⊠
24'	36'	35'	9'	Certified	A-Frame	Vertical Walls
	←Barn	Below provide a s	ketch of building		×	
					Base Price	\$2,995.00
					Leg Height	\$340.00
			+	Opti	ons	
			++++	Close Bo	th Sides	\$795.00
				Close Bo	th Ends	\$2,000.00
				Vertica	l Roof	\$700.00
				RUD mount	ted on slde	\$150.00
				1- 10x8 Ro	ll up Door	\$525.00
				1- Walk	in Door	\$300.00
			+++A++			
	door(WD) Window (W) Roll					
Install	ation Surface p	provided by cut	stomer?			
GROUND	No Warranty if	lot is unlevel	Initial			
□ CONCRETE	Slab Size	x/	Initial			
☐ OTHER			Charges may apply	'  _	SUBTOTAL	\$7,805.00
	quired? (Certified On		□ No		CO. SALES TAX	\$507.32
Add \$100 per c	opy for Florida o	nly# of	copies	Tax % 6.5	TOTAL	\$8,312.32
Limited Warranty				I.	Subtotal - Deposit	\$937.00
********	ty (Certified Only)				Balance Due	\$7,375.32
	e subject to veri			1.00	When Installed	
	Seller) this order			After installation		
	ve buyer and sel			below acknowled		
	nditions of this or read and complet		- 11	the constructed which it was built		mainer in
	read and completend the information			Customer:		
and by signin	g I agree to the al			Installer:		
conditions.						
Customer Sig	gnature:	<del></del>			<del></del>	

# Standard

- 29 Gauge MetalRoofing
- 4 Corner Braces
- 30" Rebar Anchors OR Concrete Anchors

**Starting at \$8,450.00** 

# Certified


- 29 Gauge Metal Roofing
- Fully Braced, Certified up to 130MPH Wind Rating & 20PSF Snow Load
- 30" Rebar Anchors AND High Wind Anchors OR Concrete Anchors





# Available Options

Walk-In Doors
Windows
Roll-Up Doors
Gables
Side Panels
Vertical Roof
Vertical Sides
Insulation
Skylights
Wainscoting
Interior Paneling
Color Matching Screws
40 Year Metal Upgrade

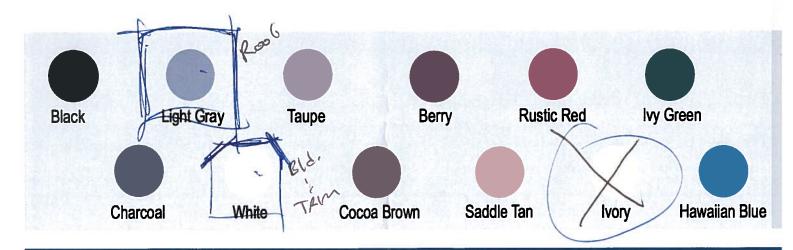

To view more structures and options, visit our website and take a look at our online catalog.

www.randbmetalstructures.com



## STRUCTURAL DESIGN

## **ENCLOSED BUILDING**

## MAXIMUM 30'- 0" WIDE X 14'- 0" HEIGHT-BOX EAVE FRAME AND BOW FRAME

10 February 2017 Revision 1 M&A Project No. 16182S

Prepared for:


R&B Metal Structures 979 Highway 42 South Jackson, GA 30233

## Prepared by:

Moore and Associates Engineering and Consulting, Inc. 1009 East Avenue North Augusta, SC 29841






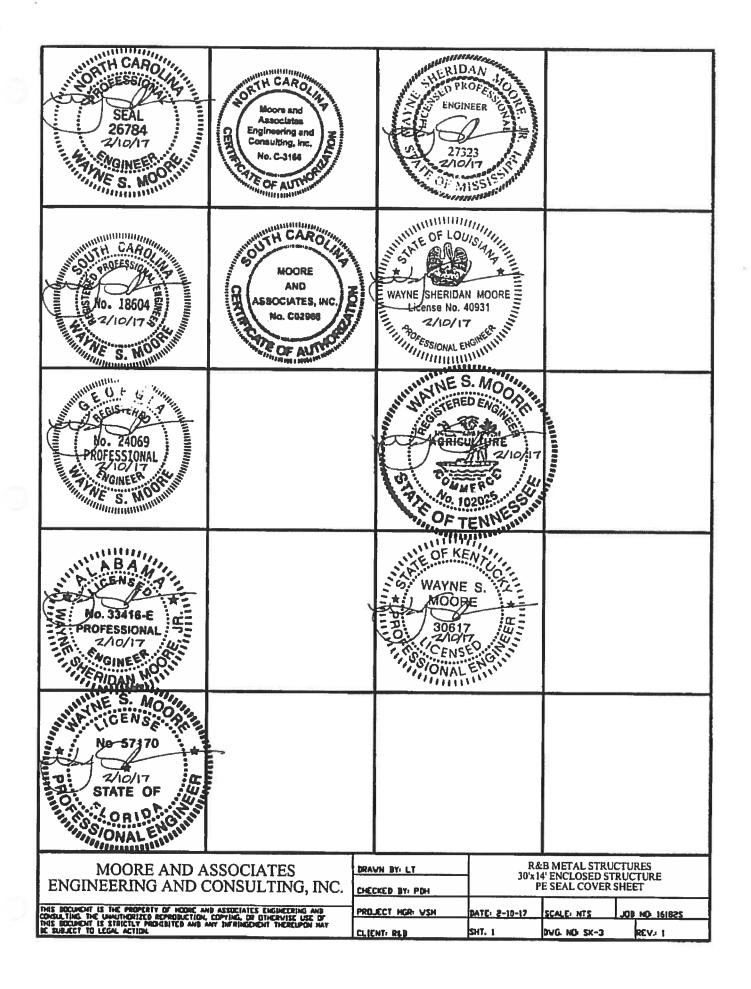


# DRAWING INDEX

	SHEET 1	PE SEAL COVER SHEET
	SHEET 2	DRAWING INDEX
l	SHEET 3	INSTALLATION NOTES AND SPECIFICATIONS AND TYPICAL SIDE AND END ELEVATIONS
l		
ĺ	SHEET 4	TYPICAL RAFTER/COLUMN END AND SIDE FRAMING SECTIONS (BOX EAVE RAFTER)
	SHEET 5A	24' < W ≤ 30' MAXIMUM RAFTER SPAN CONNECTION DETAILS (BOX EAVE RAFTER)
ı	SHEET 5B	W ≤ 24' MAXIMUM RAFTER SPAN CONNECTION DETAILS
		(BOX EAVE RAFTER)
	SHEET 6	TYPICAL RAFTER/COLUMN END AND SIDE FRAMING SECTIONS
		(BOW RAFTER)
	SHEET 7A	24' < W < 30' MAXIMUM RAFTER SPAN CONNECTION DETAILS
ı		(BDW RAFTER)
	SHEET 7B	W ≤ 24' MAXIMUM RAFTER SPAN CONNECTION DETAILS (BDW RAFTER)
	SHEET 8	BASE RAIL ANCHORAGE OPTIONS
	SHEET 9	BOX EAVE RAFTER END WALL AND SIDE WALL OPENINGS
	SHEET 10	BOW EAVE RAFTER END WALL AND SIDE WALL OPENINGS
	SHEET 11	BOX AND BOW EAVE RAFTER WALL OPENING DETAILS
	SHEET 12	BOX AND BOW EAVE RAFTER WALL OPENING DETAILS
	SHEET 13	BOX EAVE RAFTER LEAN-TO OPTION
	SHEET 14	BOW RAFTER LEAN-TO OPTION
	SHEET 15	BOX EAVE RAFTER VERTICAL ROOF OPTION
	SHEET 16	LACED HEADER DETAIL


MOORE AND ASSOCIATES ENGINEERING AND CONSULTING, INC.	DRAWN BY: LT	R&B METAL STRUCTURES 979 HIGHWAY 42 SOUTH JACKSON, GA 30233 30'x14' ENCLOSED STRUCTURE		
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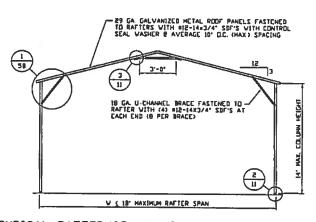
MOORE AND ASSOCIATES	DRAWN BY: LT	979 HIGHWAY 42 SOUTH		
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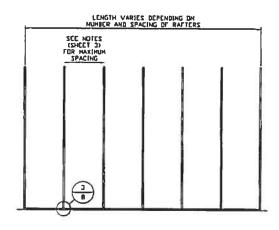
TYPICAL RAFTER/COLUMN END FRAME SECTION SCALE: NTS

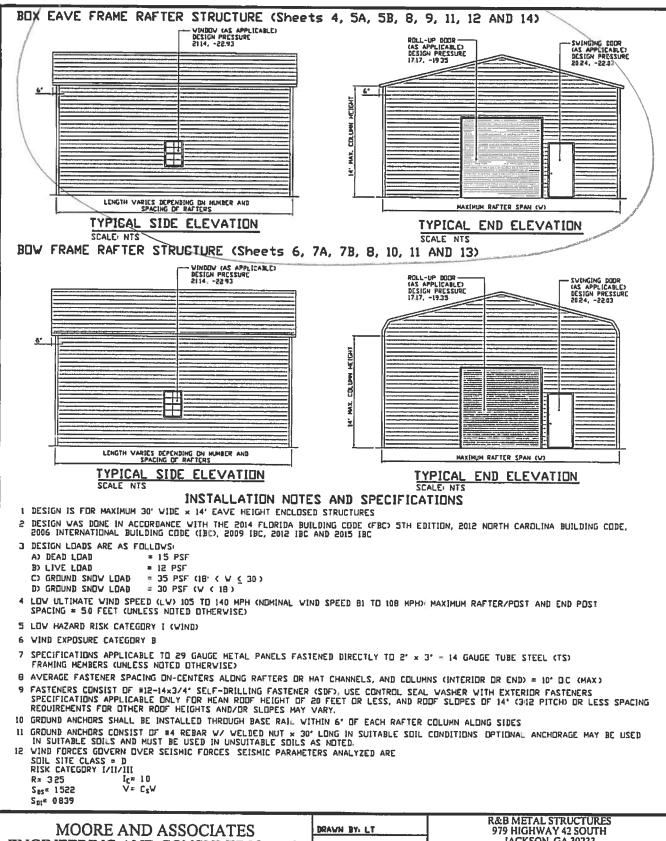

TYPICAL RAFTER/COLUMN END FRAME SECTION SCALE: NTS

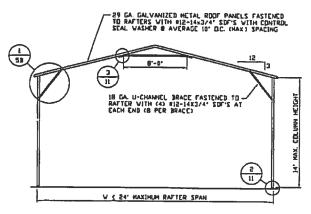


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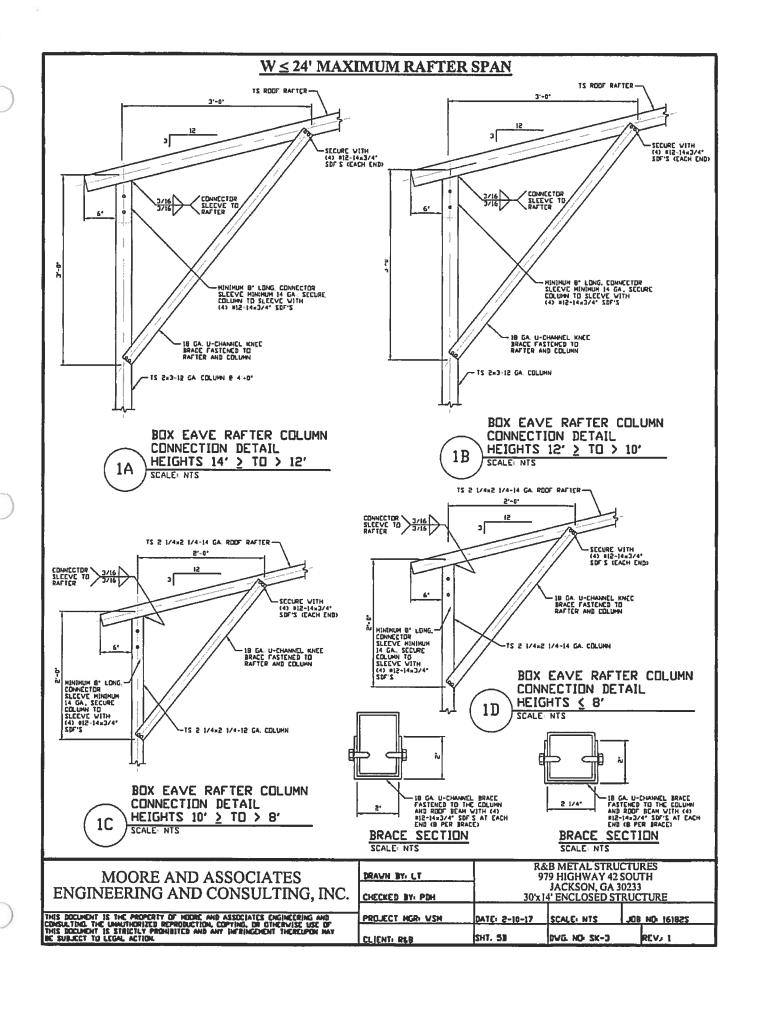


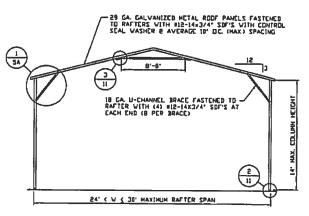
TYPICAL RAFTER/COLUMN SIDE FRAMING SECTION SCALE NTS

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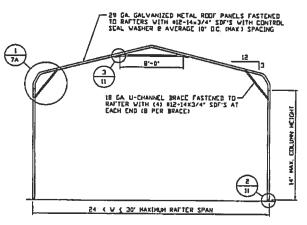
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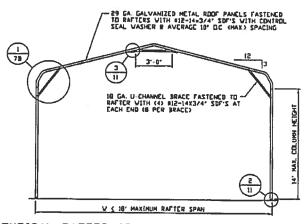





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TYPICAL RAFTER/COLUMN END FRAME SECTION SCALE: NTS

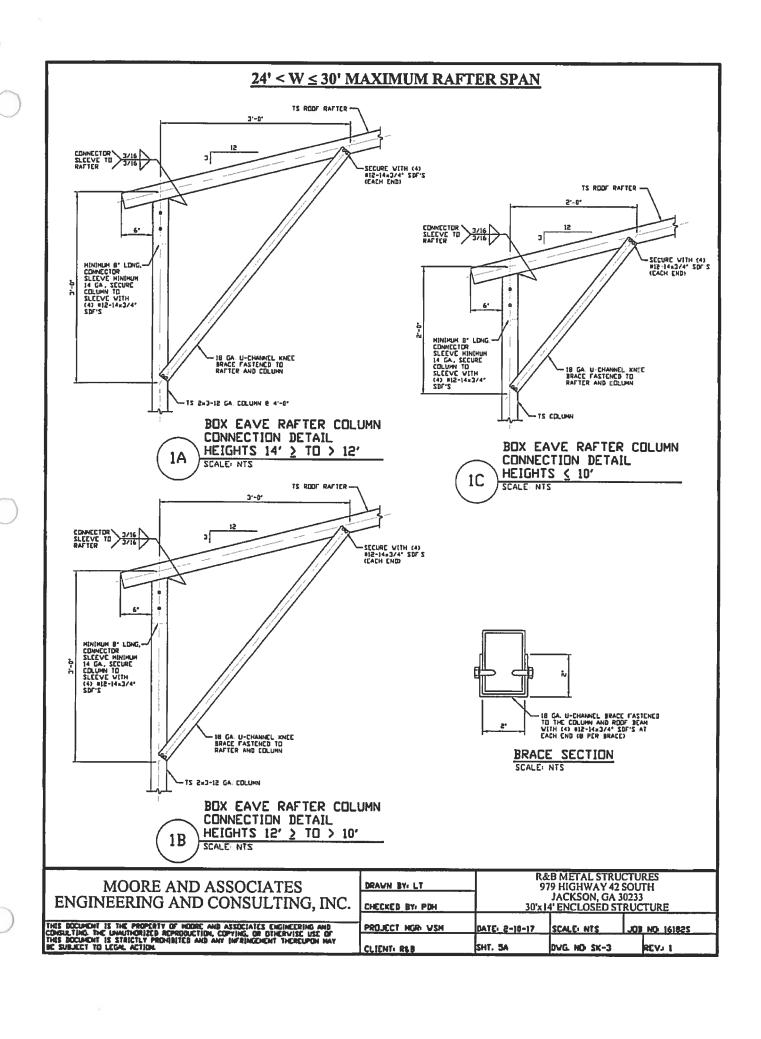


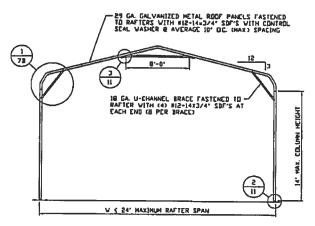
TYPICAL RAFTER/COLUMN END FRAME SECTION SCALE NTS




TYPICAL RAFTER/COLUMN SIDE FRAMING SECTION SCALE NTS

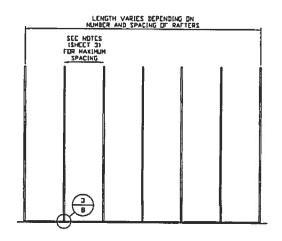MOORE AND ASSOCIATES ENGINEERING AND CONSULTING, INC.	DRAWN BY: LT CHECKED BY: PDH	R&B METAL STRUCTURES 979 HIGHWAY 42 SOUTH JACKSON, GA 30233 30'x14' ENCLOSED STRUCTURE		
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## BASE RAIL ANCHORAGE OPTIONS FOR LOW WIND SPEEDS

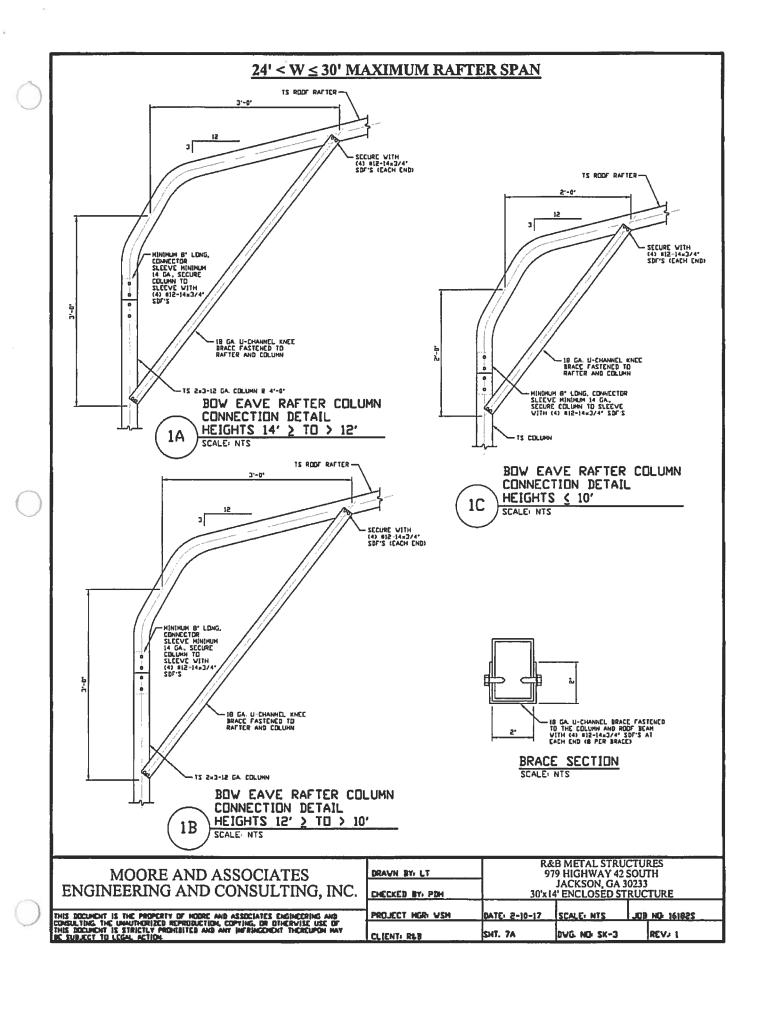

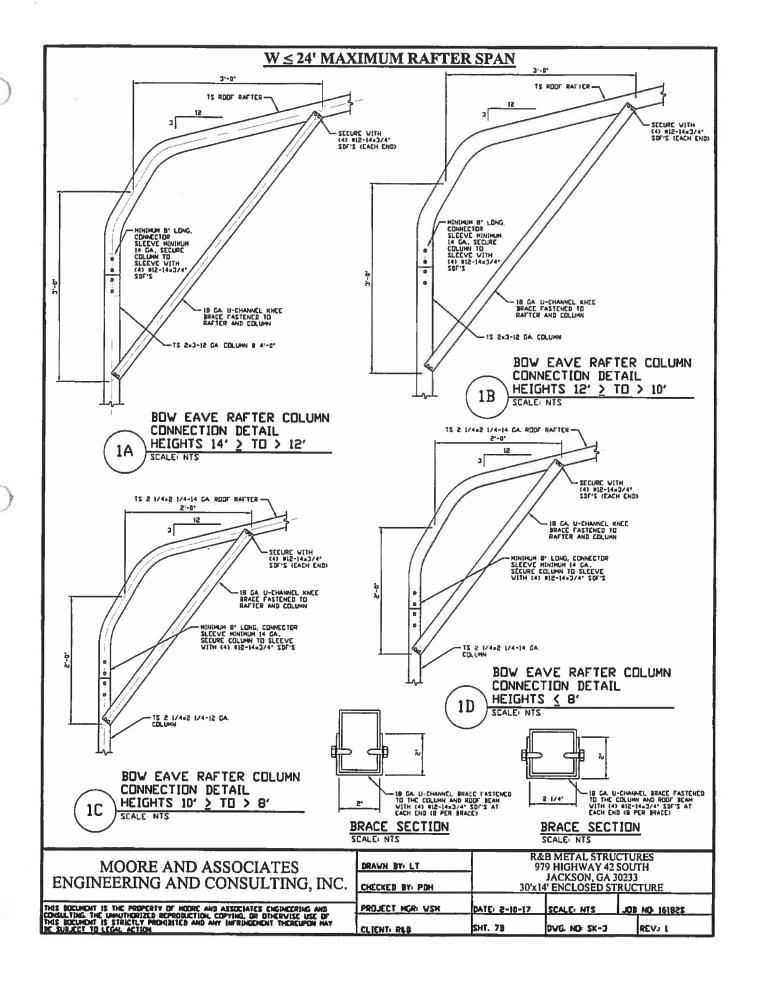

## **GENERAL NOTES**
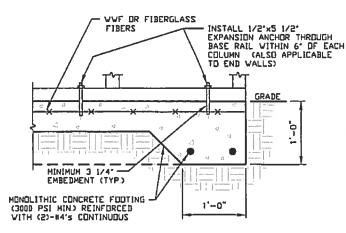
#### CONCRETE:

CONCRETE SHALL HAVE A MINIMUM SPECIFIED COMPRESSIVE STRENGTH OF 3,000 PSI AT 28 DAYS

#### COVER OVER REINFORCING STEEL:

FOR FOUNDATIONS, MINIMUM CONCRETE COVER OVER REINFORCING BARS SHALL BE PER ACI-318
3' IN FOUNDATIONS WHERE THE CONCRETE IS CAST AGAINST AND PERMANENTLY IN CONTACT VITH THE EARTH OR EXPOSED TO THE EARTH OR WEATHER, AND 1 1/2' ELSEWHERE.

#### REINFORCING STEEL:


THE TURNDOWN REINFORCING STEEL SHALL BE ASTM AGIS GRADE 60. THE SLAB REINFORCEMENT SHALL BE WELDED WIRE FABRIC MEETING ASTM A185 OR FIBERGLASS FIBER REINFORCEMENT

### REINFORCEMENT MAY BE BENT IN THE SHOP OR THE FIELD PROVIDED:


- 1. REINFORCEMENT IS BENT COLD
  2. THE DIAMETER OF THE BEND, MEASURED ON THE INSIDE OF THE BAR, IS NOT LESS THAN SIX-BAR DIAMETERS
  3. REINFORCEMENT PARTIALLY EMBEDDED IN CONCRETE SHALL NOT
- BE FIELD BENT.

## HELIX ANCHOR NOTES:

- 1. FOR VERY DENSE AND/OR CEMENTED SANDS, COARSE GRAVEL AND COBBLES, CALICHE, PRELIDADED SILTS AND CLAYS, USE MINIMUM (2) 4° HELICES WITH MINIMUM 30° EMBEDMENT OR SINGLE 6° HELIX WITH MINIMUM 50° EMBEDMENT
- 2. FOR CORAL USE MINIMUM (2) 4' HELICES WITH MINIMUM 30' EMBEDMENT OR SINGLE 6' HELIX WITH MINIMUM 50' EMBEDMENT.
- 3. FOR MEDIUM DENSE COARSE SANDS, SANDY GRAVELS, VERY STIFF SILTS, AND CLAYS USE MINIMUM (2) 4" HELICES WITH MINIMUM 30 INCH EMBEDMENT OR SINGLE 6" HELIX WITH MINIMUM 50' EMBEDMENT.
- 4. FOR LODSE TO MEDIUM DENSE SANDS, FIRM TO STIFF CLAYS AND SILTS ALLUVIAL FILL, USE MINIMUM (2) 6° HELICES WITH MINIMUM 50° EMBEDMENT.
- 5. FOR VERY LOSE TO MEDIUM DENSE SANDS, FIRM TO STIFFER CLAYS AND SILTS, ALLUVIAL FILL, USE MINIMUM (2) 8' HELICES WITH MINIMUM 60' EMBEDMENT.

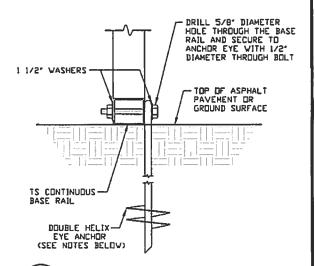


GROUND BASE HELIX ANCHORAGE SCALE NTS (CAN BE USED FOR ASPHALT)

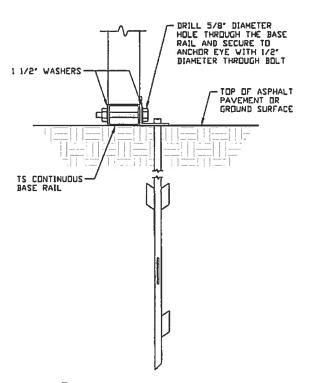

ASPHALT BASE ANCHORAGE **3C** SCALE: NTS


ENCINEEDING AND CONOUTED INC.	DRAWN BY: LT	R&B METAL STRUCTURES 979 HIGHWAY 42 SOUTH JACKSON, GA 30233 30'x14' ENCLOSED STRUCTURE		
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## BOX EAVE RAFTER END WALL AND SIDE WALL OPENINGS

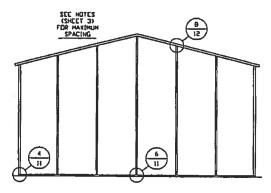


TYPICAL BOX EAVE RAFTER END WALL FRAMING SECTION

SCALE: NTS

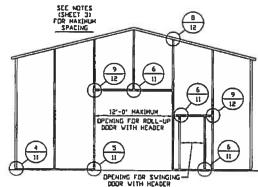

TYPICAL BOX EAVE RAFTER END WALL OPENING FRAMING SECTION


SCALE: NTS

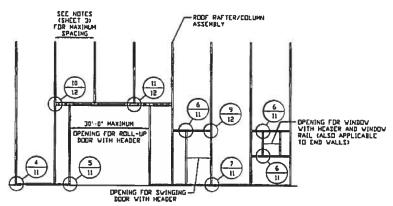


TYPICAL BOX EAVE RAFTER SIDE WALL OPENINGS FRAMING SECTION SCALE NTS

MOORE AND ASSOCIATES ENGINEERING AND CONSULTING, INC.	DRAWN BY: LT	97	B METAL STRUC 19 HIGHWAY 42 S JACKSON, GA 30 4' ENCLOSED STR	OUTH 0233
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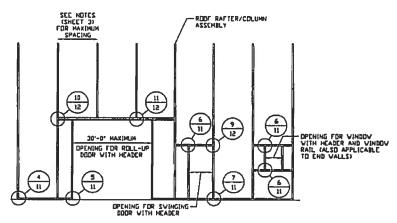
## **BOW EAVE RAFTER END WALL AND SIDE WALL OPENINGS**

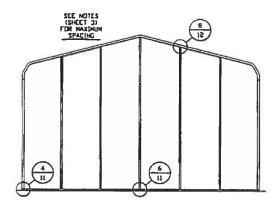

TYPICAL BOW EAVE RAFTER END WALL FRAMING SECTION

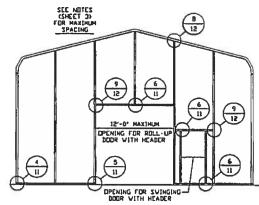


TYPICAL BOW EAVE RAFTER END WALL OPENING FRAMING SECTION SCALE NTS




TYPICAL BOW EAVE RAFTER SIDE WALL OPENINGS FRAMING SECTION SCALE NTS

MOORE AND ASSOCIATES ENGINEERING AND CONSULTING, INC.	DRAWN BY: LT CHECKED BY: PDH	R&B METAL STRUCTURES 979 HIGHWAY 42 SOUTH JACKSON, GA 30233 30'x14' ENCLOSED STRUCTURE		OUTH 0233
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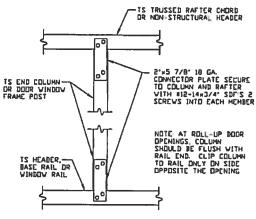
## **BOX AND BOW EAVE RAFTER WALL OPENING DETAILS**

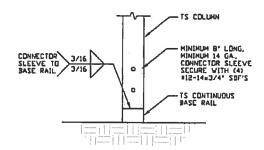


RAFTER COLUMN/BASE RAIL CONNECTION DETAIL
SCALE NTS

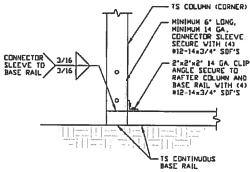


4 END COLUMN/BASE RAIL CONNECTION DETAIL SCALE NTS




6 COLUMN TO WINDOW RAIL CONNECTION DETAIL

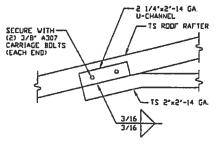

8' ROOF RAFTER TIE CONNECTION DETAIL FOR W & 30' SCALE NTS

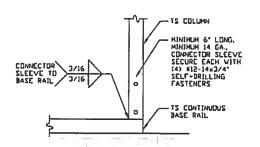


5 COLUMN/BASE RAIL CONNECTION DETAIL SCALE NTS

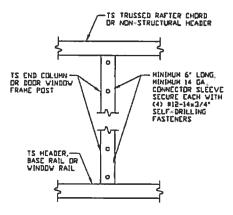


COLUMN TO HEADER OR BASE RAIL CONNECTION DETAIL SCALE NTS

MOORE AND ASSOCIATES	BRAWN BY: LT	R&B METAL STRUCTURES 979 HIGHWAY 42 SOUTH JACKSON, GA 30233			
	PROJECT HGR: VSH	30'x14' ENCLOSED STRUCTURE  DATE: 8-10-17   SCALE: NTS   JOB NO: 161825			
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## **BOX AND BOW EAVE RAFTER WALL OPENING DETAILS**




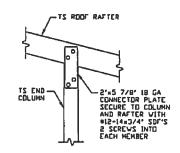

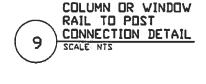


2'x2'x2' 14 GA ANGLE CLIP SECURE TO COLUMN AND EITHER TOP OF HEADER, DR BOTTOM OF VINDOW RAIL VITH 812-14\*3/4' SDF'S

TS HEADER OR VINDOV RAIL

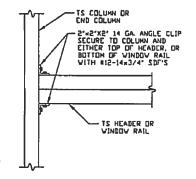




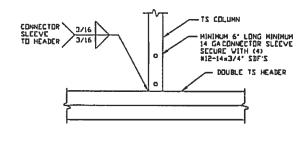


	COLUMN /LA	CED HEADER
(11)	COLUMN /LA	DETAIL
(")	SCALE: NTS	

MOORE AND ASSOCIATES ENGINEERING AND CONSULTING, INC.	DRAWN BY: LT CHECKED BY: PDH	R&B METAL STRUCTURES 979 HIGHWAY 42 SOUTH JACKSON, GA 30233 30'x14' ENCLOSED STRUCTURE		SOUTH 0233
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## **BOX EAVE RAFTER LEAN-TO OPTIONS**

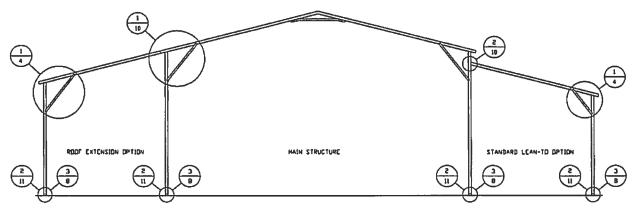


TYPICAL BOX EAVE RAFTER LEAN-TO OPTIONS FRAMING SECTION (BOTH OPTIONS SHOWN)

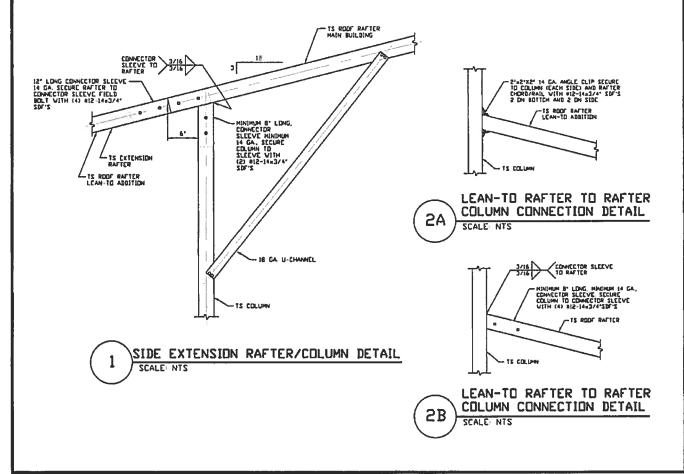


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MOORE AND ASSOCIATES ENGINEERING AND CONSULTING, INC.	CHECKED BY: PDH	R&B METAL STRUCTURES 979 HIGHWAY 42 SOUTH JACKSON, GA 30233 30'x 14' ENCLOSED STRUCTURE		OUTH 0233

## **BOW RAFTER LEAN-TO OPTIONS**

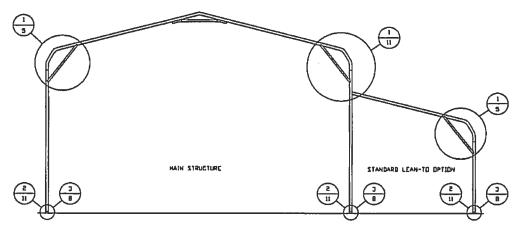


TYPICAL BOW RAFTER LEAN-TO OPTION FRAMING SECTION SCALE NTS

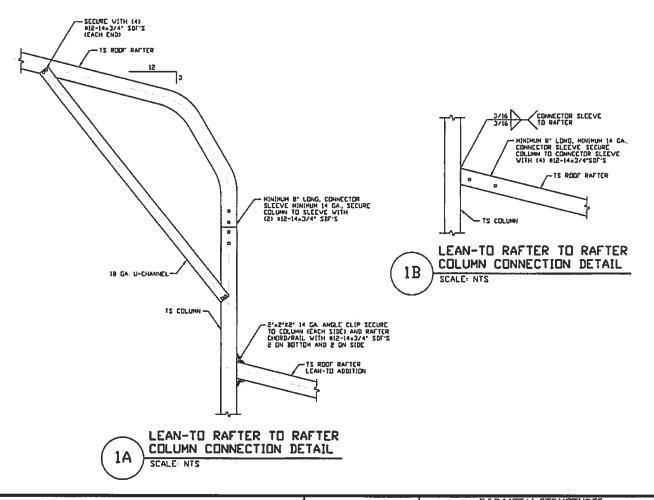


MOORE AND ASSOCIATES ENGINEERING AND CONSULTING, INC.	DRAVN BY: LT	9	R&B METAL STRUCTURES 979 HIGHWAY 42 SOUTH JACKSON, GA 30233 30'x14' ENCLOSED STRUCTURE		
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## BOX EAVE RAFTER VERTICAL ROOF OPTION

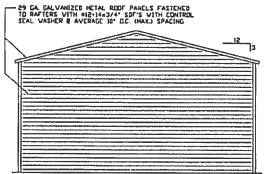


TYPICAL END ELEVATION VERTICAL ROOF


SCALE: NTS

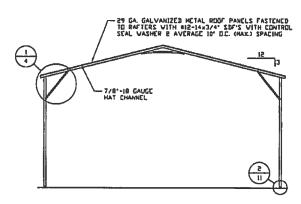


TYPICAL SECTION VERTICAL ROOF OPTION
SCALE: NTS

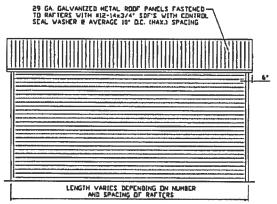

TYPICAL SIDE ELEVATION VERTICAL ROOF SCALE: NTS

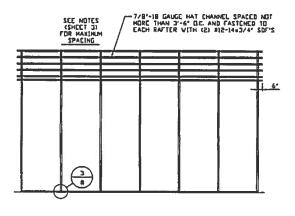

TYPICAL FRAMING SECTION VERTICAL ROOF OPTION SCALE: NTS

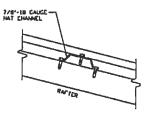

ROOF PANEL ATTACHMENT
(ALTERNATE FOR VERTICAL ROOF PANELS)
SCALE NTS


MOORE AND ASSOCIATES ENGINEERING AND CONSULTING, INC.	DRAVN BY: LT	R&B METAL STRUCTURES 979 HIGHWAY 42 SOUTH JACKSON, GA 30233 30'x14' ENCLOSED STRUCTURE		SOUTH D233
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## **LACED HEADER OPTION**

### 2 1/4 HEADER OPTION


# 2 1/4×2 1/4-14 GA (TYP) 2 1/4×2 1/4-14 GA 1'-8' 0C (TYP) 3/16 TYP

B' < LENGTHS & 22'

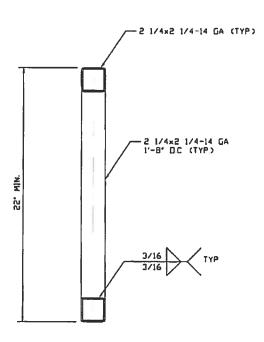


SCALE: NTS

### 2×3 HEADER OPTION

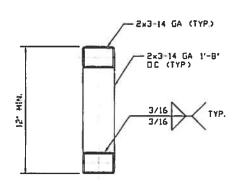



10' C LENGTHS & 22'

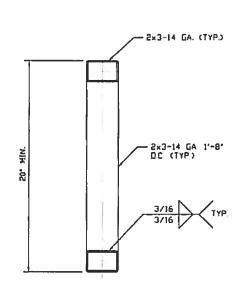


22' C LENGTHS C 30'

MOORE AND ASSOCIATES	DRAVN BY: LT	R&B METAL STRUCTURES 979 HIGHWAY 42 SOUTH JACKSON, GA 30233				
ENGINEERING AND CONSULTING, INC.	CHECKED BY: PDH	30'x 1-	30'x14' ENCLOSED STRUCTURE			
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Parcel: 03654-000-000

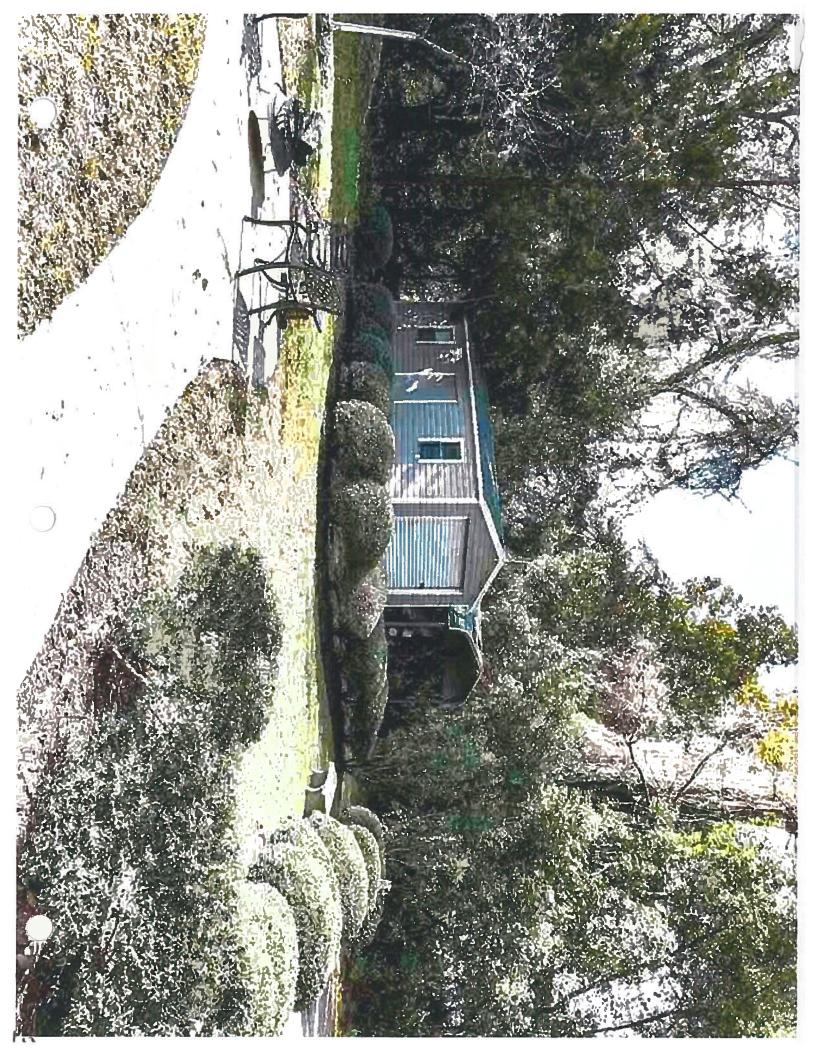Search Date: 9/18/2017 at 12:22:01 PM

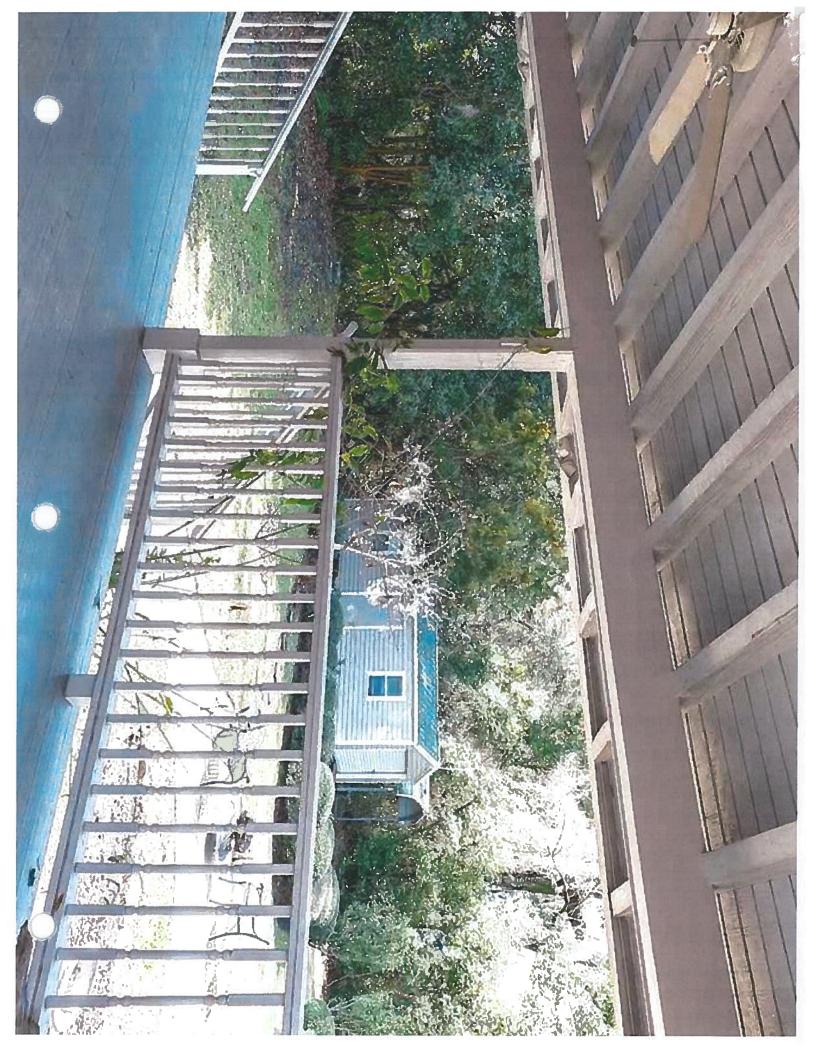Taxpayer:

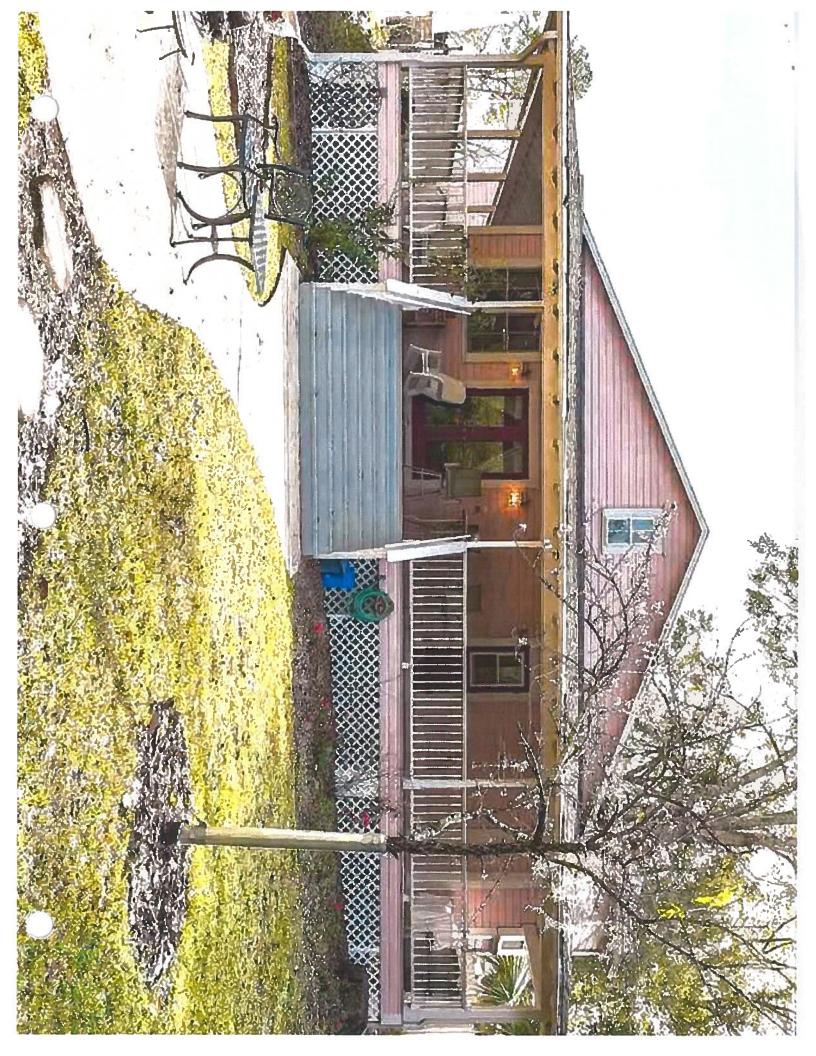HANES LEROY & SIOBAN

Mailing:

28101 W NEWBERRY RD NEWBERRY, FL 32669

ocation:

14720 MAIN ST ALACHUA

Sec-Twn-Rng: 15-08-18

Property Use: 00100 - Single Family Tax Jurisdiction: Alachua - 1700

Area:

Downing Addn

Subdivision:

Olmsteads Survey of Alachua &C-79B

Legal: OLMSTEAD SURVEY PB C-79B N1/2 OF LOT 4 BK 5 OR 4536/1229

	Property	Land	Land	Building	Misc	Total	Deferred	County	School	County	School	County	School	Total
YeaR	Use	Assessed Value	Just Value	Value	Value	Just Value	Value	Assessed	Assessed	Exempt	Exempt	Taxable	Taxable	Taxes
2016	Single Family	47500	47500	89800	5200	142500	23730	118770	118770	50000	25000	68770	93770	1911.87
2015	Single Family	47500	47500	93500	5200	146200	28250	117950	117950	50000	25000	67950	92950	1934.03
2014	Single Family	47500	47500	92500	5300	145300	28280	117020	117020	50000	25000	67020	92020	1893.44
2013	Single Family	47500	47500	94700	5700	147900	32600	115300	115300	50000	25000	65300	90300	1850.44
2012	Single Family	47500	47500	96900	6200	150600	37220	113380	113380	50000	25000	63380	88380	1802.27
2011	Single Family	47500	47500	102500	6500	156500	46420	110080	110080	50000	25000	60080	85080	1766.96
2010	Single Family	47500	47500	108600	6800	162900	54440	108460	108460	50000	25000	58460	83460	1714.9
2009	Single Family	47500	47500	117900	6800	172200	67070	105130	105130	50000	25000	55130	80130	1640.6
2008	Single Family	47500	47500	126700	7100	181300	76270	105030	0	50000	0	55030	0	1479.45
2007	Single Family	47500	47500	124300	7500	179300	77320	101980	0	25000	0	76980	0	1772.65

Land

Use	Zoning Type	Zoning Desc	Unit Type	Units
SFR	CBD		Square Feet	19000
			2016 Certified Land Just Value: 47500	2016 Certified Land Assessed Value: 47500

	Bu	ilding
Actual Year Built	1920	Footprint_file = 13625_13625.jpg
Effective Year Built	1987	
building Quality	Average	
Building Style	Single Family	200 22 25 25 25 200 200 200 200 200 200
Building Use	Single Family	380
Bedrooms:	3	
Baths:	2.0	15
Stories:	1.0	FCP (TOT of) 55
Exterior Wall 1:	Single Siding	44/44
Exterior Wall 2:	N/A	
Interior Wall 1:	Drywall	
Interior Wall 2:	N/A	P4 BAS (2.442 d)
Floor Cover 1:	Pine/Soft Wood	
Floor Cover 2:	N/A	16 5
Roof Cover:	Asphalt	5 10
Roof Structure:	Gable/Hip	
AC:	Central	
Heating Type:	Forced Air	25 16
Heating System:	Gas	11/61
Total Square Feet:	3625	F0P
Heated Square Feet:	2482	24 (16-10) 19 4 22
Area Type	Square Footage	
BAS (BASE AREA)	2482	[ <sup>W</sup> 10 2
FOP (FINISHED OPEN PORCH)	1143	
		2016 Certified Building Value: 89800

Miscellaneous

	Miscellaneous					
Description	Unit Type	Units				
0800 - Drive/Walk	SF	3072				
2221 - Stg 1	SF	264				
721 - Deck 1	SF	76				
0721 - Deck I	SF	66				
0958 - FP 1	UNITS	1				
0662 - CP 2	SF	312				
2016 Certified Miscellaneous Value: 5200						

Sale

Date	Price	Vac/Imp	Qualified	OR Book	OR Page	Instrument
08/03/2017	279000	I	Q	4536	1229	MS
05/28/2001	100	I	U	2362	2649	QD
01/30/1998	60000	I	Q	2151	644	WD
0/01/1979	0	1	U	1255	726	WD

Parcel: 03652-001-000

Search Date: 9/18/2017 at 12:21:34 PM

Taxpayer:

HANES LEROY & SIOBAN

Mailing:

28101 W NEWBERRY RD NEWBERRY, FL 32669

Location:

Sec-Twn-Rng: 15-08-18

00000 - Vacant Property Use:

Tax Jurisdiction: Alachua - 1700 15-8-18 Alachua Area:

Subdivision:

Olmsteads Survey of Alachua &C-79B

Legal: OLMSTEAD SURVEY PB C-79B E 38 FT OF THE N1/2 OF LOT 3 BK 5 OR 4536/1229

	Property	Land	Land	Building	Misc	Total	Deferred	County	School	County	School	County	School	Total
YeaR	Use	Assessed Value	Just Value	Value	Value	Just Value	Value	Assessed	Assessed	Exempt	Exempt	Taxable	Taxable	Taxes
2016	Vacant	7400	7400	0	0	7400	0	7400	7400	0	0	7400	7400	182.61
2015	Vacant	7400	7400	0	0	7400	0	7400	7400	0	0	7400	7400	186.13
2014	Vacant	7400	7400	0	0	7400	0	7400	7400	0	0	7400	7400	183.75
2013	Vacant	7400	7400	0	0	7400	0	7400	7400	0	0	7400	7400	183.7
2012	Vacant	7400	7400	0	0	7400	0	7400	7400	0	0	7400	7400	183.43
2011	Vacant	7400	7400	0	0	7400	0	7400	7400	0	0	7400	7400	187.46
2010	Vacant	7400	7400	0	0	7400	0	7400	7400	0	0	7400	7400	186.09
2009	Vacant	7400	7400	0	0	7400	0	7400	7400	0	0	7400	7400	185.19
2008	Vacant	7400	7400	0	0	7400	0	7400	0	0	0	7400	0	167.66
2007	Vacant	7400	7400	0	0	7400	0	7400	0	0	0	7400	0	168.27

Land

Use	Zoning Type	Zoning Desc	Unit Type		Units
Vacant Residential	CBD		Lot		1
				2016 Certified Land Just Value: 7400	

Sale

tu-						
Date		Vac/Imp	Qualified		OR Page	Instrument
08/03/2017	279000	V	Q	4536	1229	MS
2/20/2004	7500	V	Q	2863	173	WD





2016 Roll Details — Real Estate Account At 14720 MAIN ST Real Estate Account \$03654 000 000

Parcel details

Full bill history

2016 PAID

2014 2015 PAID PAID

2013 PAID

2002 PAID

Latest bill

Get Bills by Email

PAID 2016-11-22 \$1,835.40

Receipt #16-0029662
Owner: MORSE WALLIS J & ROSANNE T

PO BOX 669 ALACHUA, FL 32816 Situe: 14720 MAIN ST

Account number: 03654 000 000 Alternate Key: 1013469 Millage code: 1700 Millage rate: 24,6764 Escrow company: CHASE (200136) 1 CORELOGIC DR WESTLAKE, TX 76262

Assessed value: 118,770 School assessed value: 118,770 Unimproved land value: 47,500

Exemptions

HOMESTEAD: 25,000 HOMESTEAD ADD'L 25K: 25,000

Property Appraiser

2016 Annual bill

Ad valorem: \$1,895.40

Non-ad valorem: \$16.47 Total Discountable: 1911.87 No Discount NAVA: 0.00

Legal description

OLMSTEAD SURVEY PB C-79B N1/2 OF LOT 4 BK 5 OR 2151/8644 & OR 2362/2649

Book, page, item: 2362-2649-Ceo number: 15-08-18-03654000000 Range: 18 Township: 08 Section: 15 Nelghborhood: 233214.04

Use code: 00100 Total acres: 0.436











Vlew



# Section 5 HANES CERTIFICATE OF APPROPRIATEESS APPLICATION

### 1. Affect Exterior Appearance:

This home was built in circa 1920 with an addition added in 2003. The house was originally yellow and was painted white for many years until circa 2000 when it was painted pink.

### 2. Affect Consistent with Historical, Architectural, or Other Relevant Qualities:

Pink is not a historic color for the home. Proposed colors are Castle Beige for the main color and Ultra White trim with Black doors and screen frames.

### 3. Negative or Positive Impact on Neighboring Lands of Historical Significance:

Painting the house a neutral color is in line with other homes in the historic district. There is no negative impact to the area.

### 4. Effect of Denial:

We did not know we needed permission to paint our home from pink to white and have already purchased the paint.

### 5. Demolition:

There is no demolition.



14720 Main st. 1989



