

DECEMBER 4, 2019
DRAWN BY:
CRAIG R. HEDGECOCK
CHECKED BY:
CRAIG R. HEDGECOCK
DRAWING NO.
DREYERS SP6

RS - SURVEYORS CRA 30ULEVARD CRA (352) 377-9928 DRM


ENGINEERS - PLANNERS
27 N.W. 48TH BOL

DATE: DEC. 10, 2019
RESUBMISSION COMMENT.
DATE: DEC. 14, 2019
RESUBMISSION COMMENT.

FOR REVIEW ONL

1**TE PLAN** 5 FOR: DREYER'S DKI 1 – TAX PARCEL NO. 03211–003–000

SHEET 1 OF 5

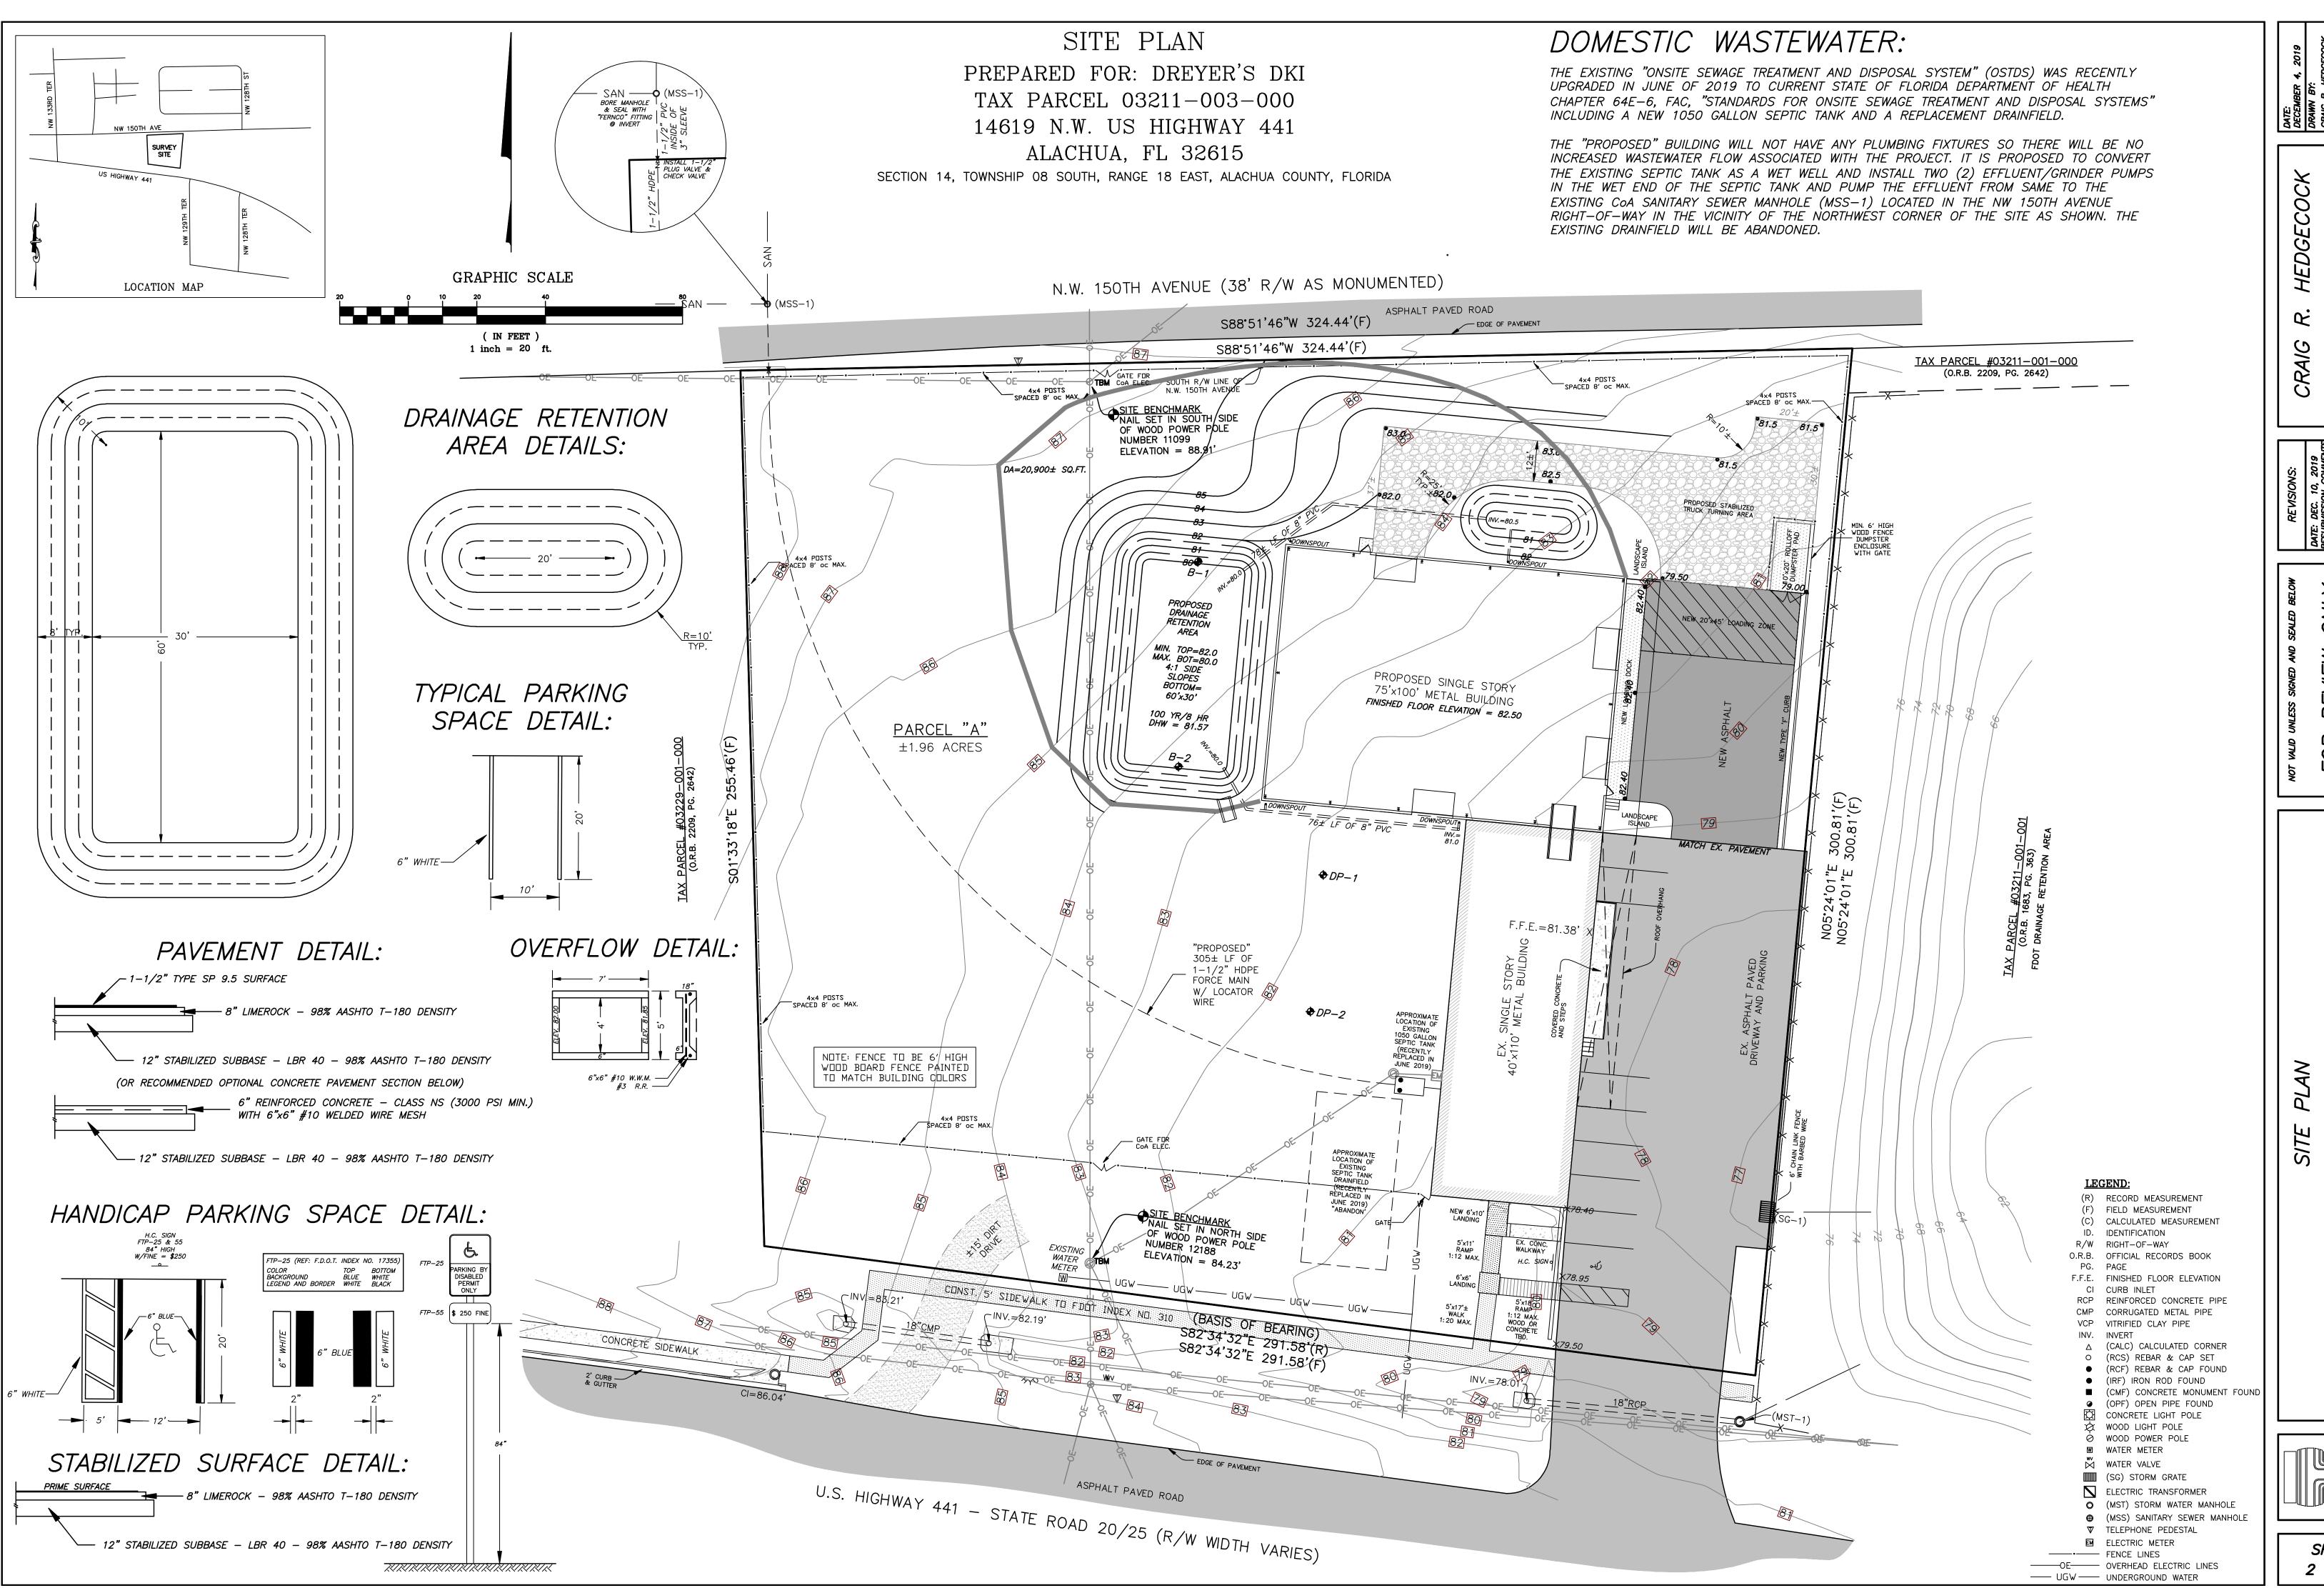


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RAIG R. HEDGECOCI WEERS - PLANNERS - SURVEYO 27 N.W. 48TH BOULEVARD


DATE: DEC. 10, 2019
RESUBMISSION COMMENTS
DATE: DEC. 12, 2019
RESUBMISSION COMMENTS


OR REVIEW ONLY
G.R. HEDGECOCK, PE/PSM DATE
NO. 24651 - P.S.M. NO. 3506 - FLORIDA

SITE PLAN
PREPARED FOR: DREYER'S DKI
HIGHWAY 441 - TAX PARCEL NO. 03211-003-0

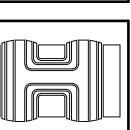

SHEET
2 OF 5

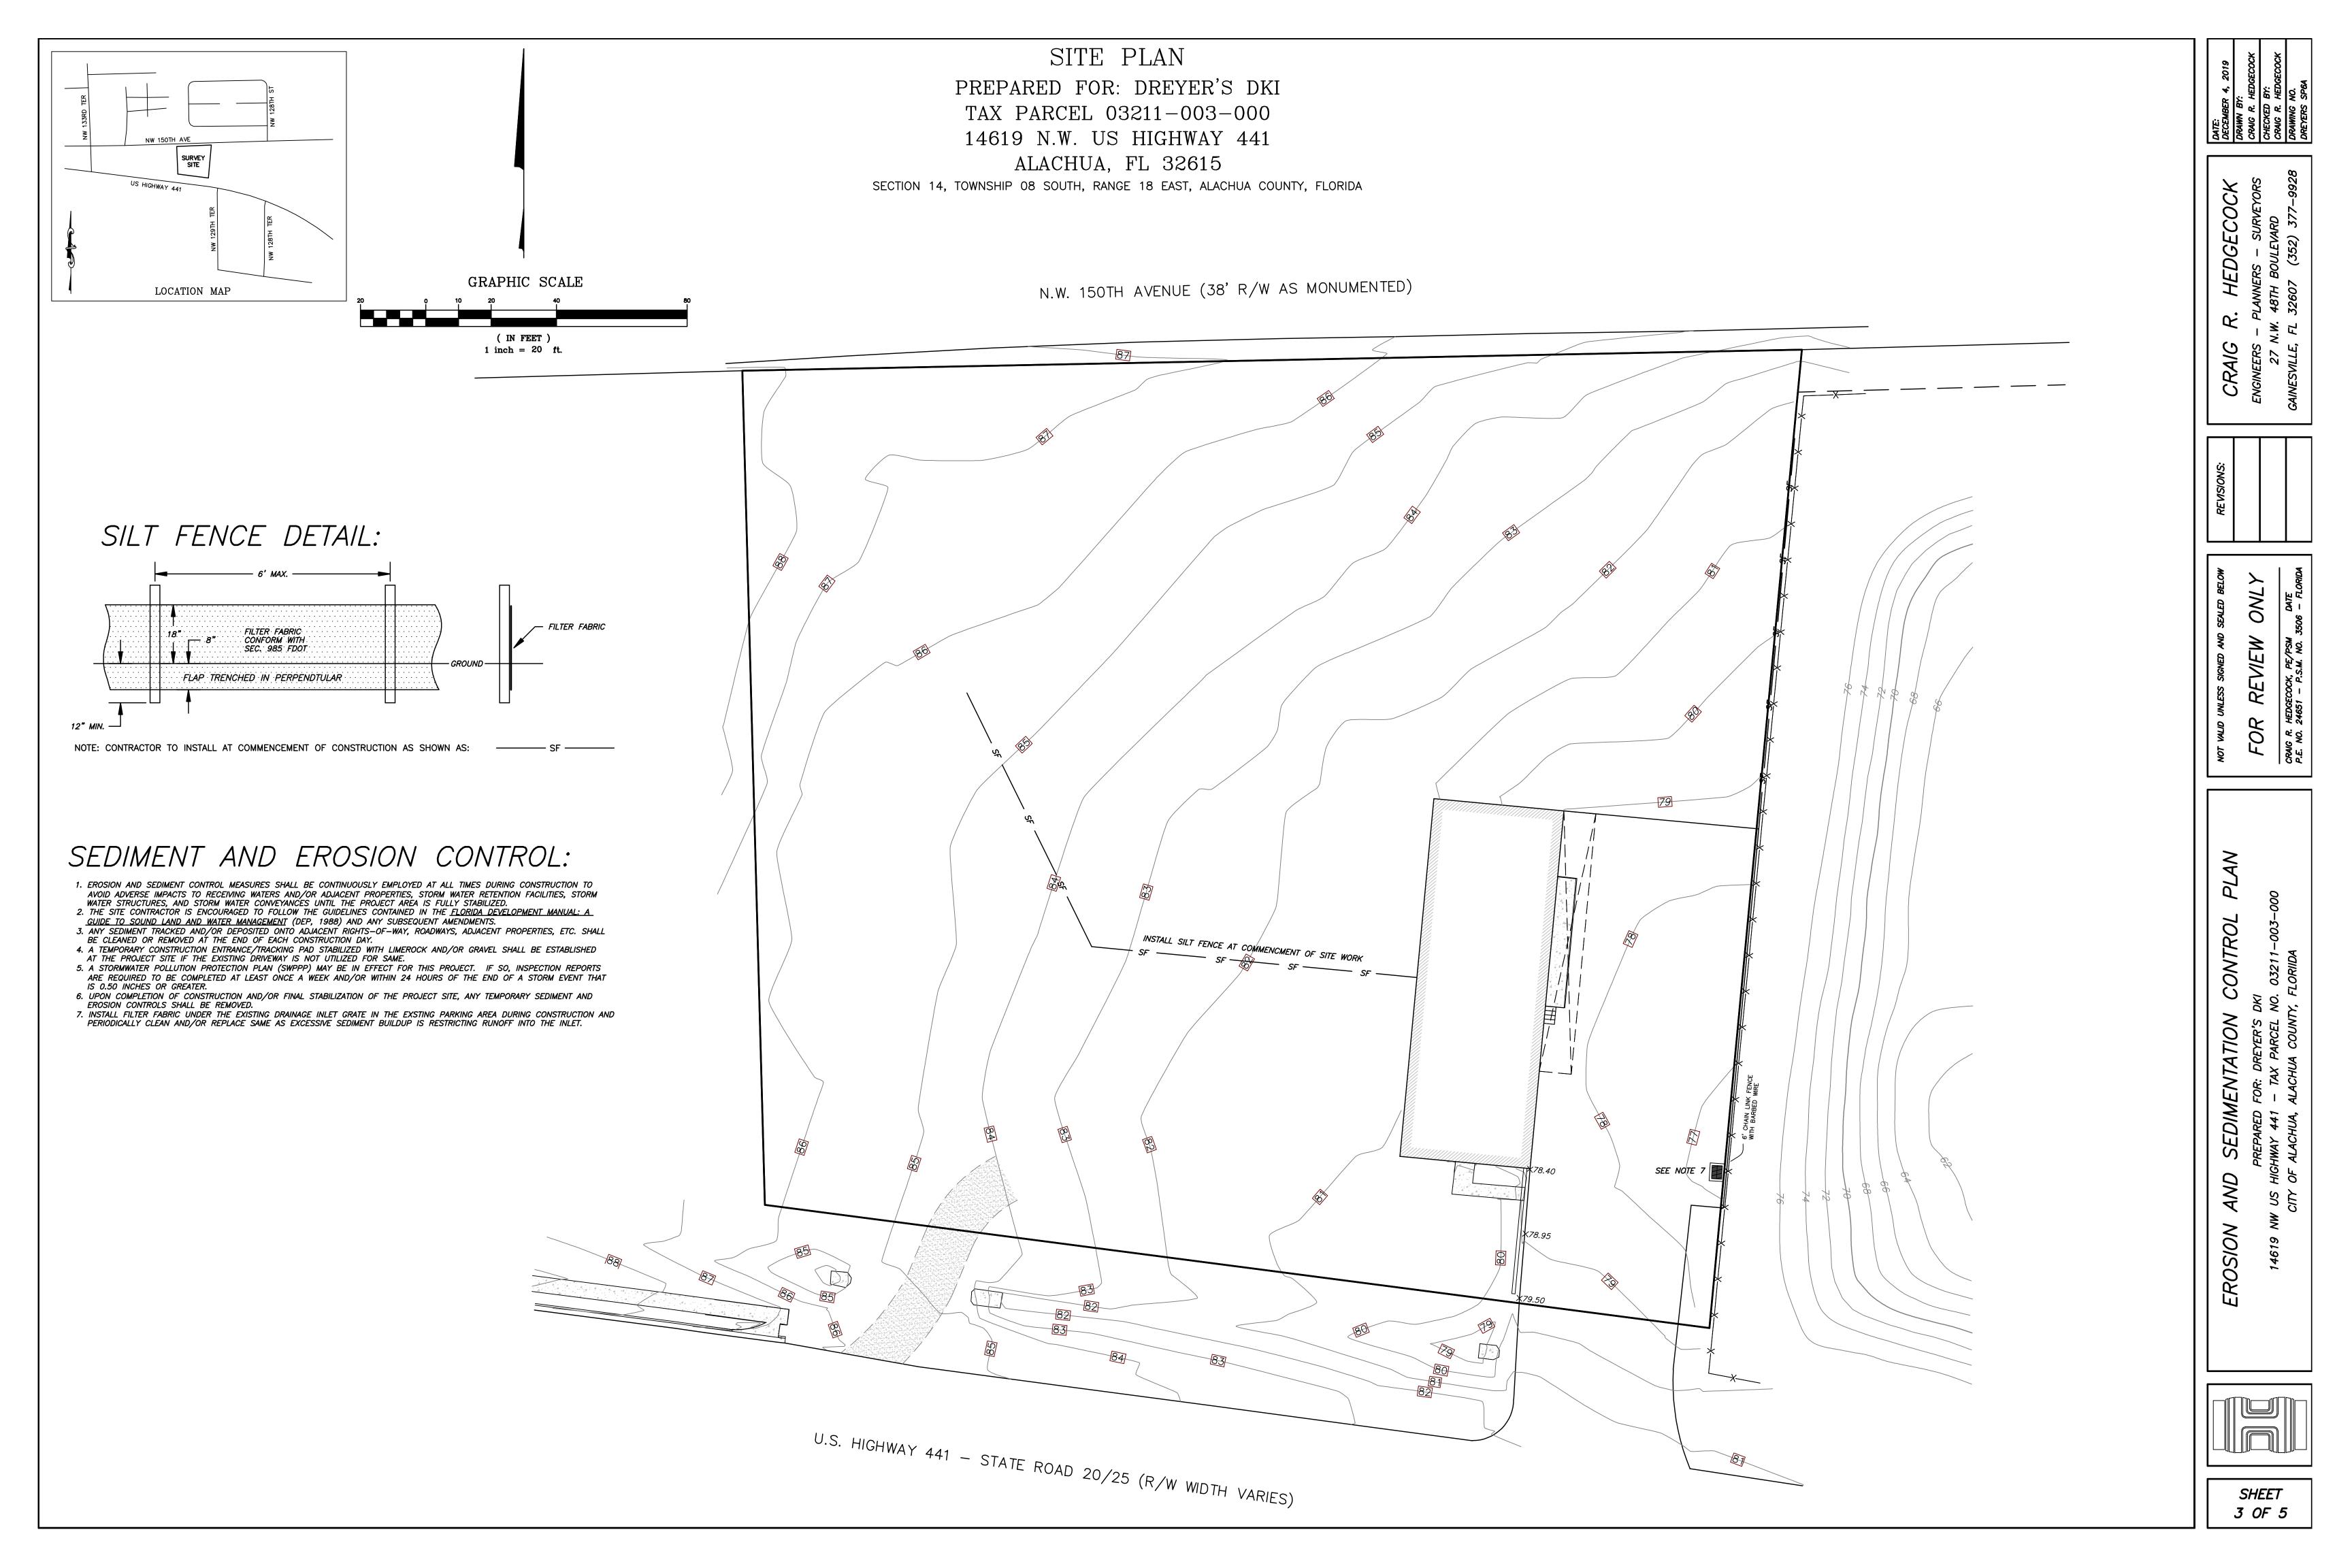

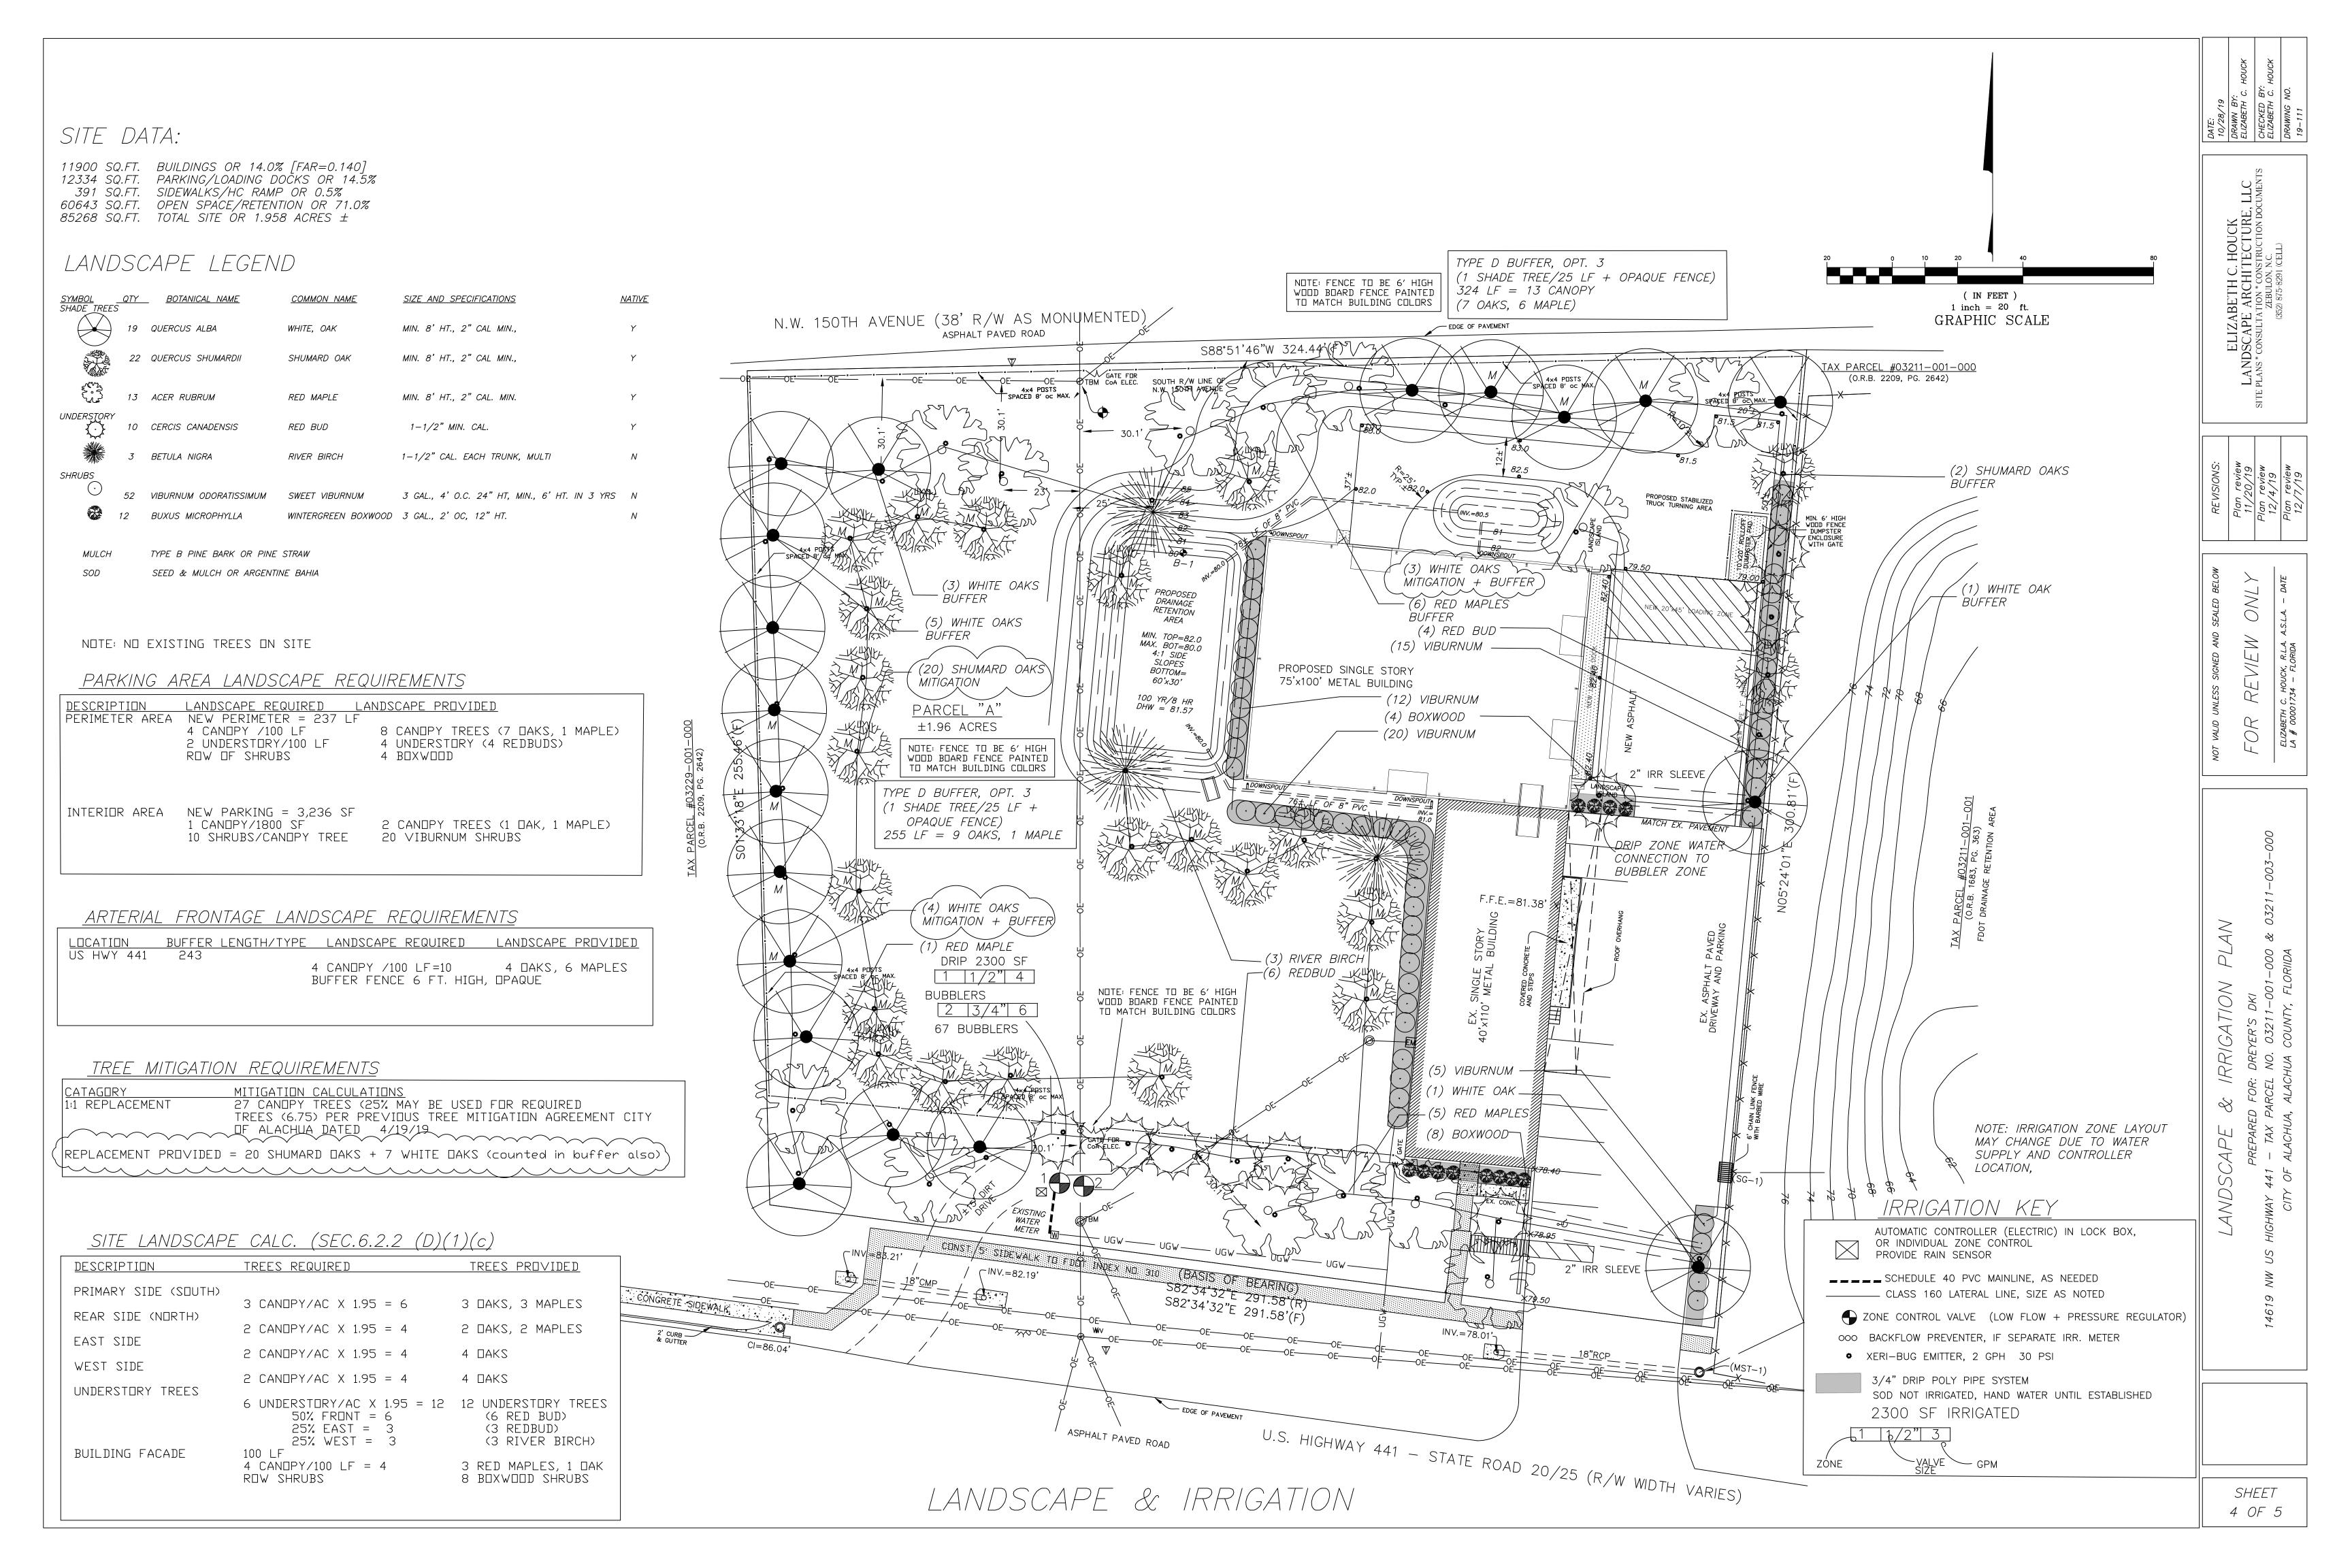

2. The Contractor shall be responsible for providing all labor, materials, and accessories required for complete irrigation systems meeting the performance requirements outlined herein.

3. All work shall be installed in accordance with the regulations of the local, county, or other governing authorities. Fees for all permits, inspections, and impact fees required shall be included as work required.

4. The water source shall be existing potable meter. Design data shall be verified by the Contractor prior to installation.

5. A rain sensor device, Mini-Clik II, or approved equal, shall be installed for each controller installed.

6. All remote control valves, gate valves, ball valves, hose bibs and wire splices shall be installed in a suitable Ametek-type valve box of proper size as required for easy access to the valve. Valve boxes shall have a sump of 1 cf gravel. Valve boxes shall be set flush and sloped with the surrounding grade.

7. All PVC pipe in the system less than 2" O.D. except risers, shall be Class 160 PSI Polyvinyl Chloride solvent weld pipe conforming to the ASTM-D2466, Type 1, requirements, NSF approved.

^{8.} All PVC pipe in the system greater or equal to 2" O.D. and fittings shall be Schedule 40, Type 1, NSF approved conforming to the ASTM-D2466 requirements.

a All wiring, if required, shall be U.L. U.F. wiring. A separate power wire shall be installed from the controller to each individual valve. Wiring shall be installed with main lines where possible; when not, it shall be installed in conduit. Waterproof wire connectors shall be used for controller wiring.

Provide pressure compensating devices as necessary to reduce misting.

10. Verify the presence of all sleeving before commencing work. Where piping must pass under existing concrete or pavement, it shall be jacked or jetted where possible. Only if impossible to get in place without cutting pavement, permission will be given by the Owner to cut paving. If this is necessary, all cutting and replacing of the paving to match the existing shall be included under this section of the specifications.

11. All PVC piping and wiring shall be installed in the trenches with a minimum of 12" of cover and a maximum depth of 24", except where specific permission is obtained from the Landscape Architect and/or Owner for less cover due to existing conditions. Where necessary because of landscaping, cover shall be as deep as required.


12. All flex pipe shall be buried to a depth of at least 4" (or covered with 3" of mulch) except where the tubing daylights over newly planted rootballs.

13. All emitters and flood bubblers shall be installed at the rootball and be minimally visable above the mulch.

14. The Contractor shall warrant the installation workmanship for a period of one year from date of job completion and retainage release. The Contractor shall further see to the fulfillment of all manufacturer's warranties and shall provide an Owner's Manuals. A reproducible as—built copied from the original showing all dimensioned system components shall be required for final job acceptance.

15. Irrigation System to include backflow device. Rainsensor to be installed at controller.

F TREE HAS INDIVIDUAL BUBBLER OR DRIP IRRIGATION, WIRE SHALL NOT TOUCH OR RUB ADJACENT BRANCHES OR TRUNKS. KEEP MULCH 6" FROM TRUNK, 3" DEPTH; APPLY PRE-EMERGENT HERBICIDE BEFORE ADDING MULCH. REMOVE ALL GUYS WITHIN ONE YEAR OF INSTALLATION FORM SAUCER WITH 3" CONTINUOUS RING 12" COMPACTED PLANTING SOIL BELOW ROOTBALL TREE PLANTING DETAIL

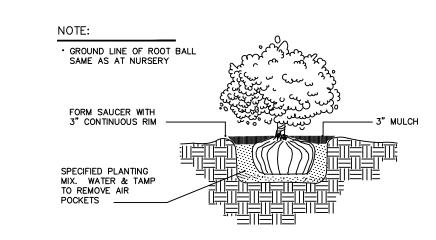

PLANTING PIT TO BE TWICE DIAMETER OF ROOT BALL (MIN. 6" EACH SIDE)



Table 1. Watering schedule for newly planted trees and shrubs

Weeks after planting: Watering frequency:

Every 2-3 days Until established* Weekly


* See Table 2 for tree establishment time. Shrubs establish in 1-2 years.

Newly planted shrubs are considered established when their root spread equals the spread of the above-ground canopy. Establishment times for trees increases with tree size. Trunk caliper at planting time can be used to determine the time it takes for roots to establish (Table 2).

Table 2. Establishment time and watering volume for newly planted trees.

Caliper (inches) Root establishment time for trees (years) Water applied during each irrigation (gallons)

BUBBLER NOZZLE-

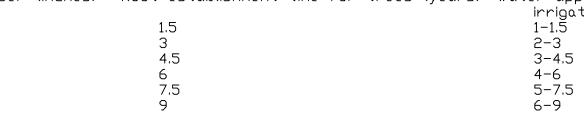

*apply 1-1 1/2 gallons per inch of stem caliper at each watering

LANDSCAPE NOTES

- 1. All plants shall be Florida No. 1 or better, as outlined under <u>Grades</u> and Standards for Nursery Plants, Division of Plant Industries, State of Florida, latest edition.
- 2. All work shall be performed in accordance with standard and accepted nursery practices in a workmanlike manner.
- 3. The Landscape Contractor shall be responsible for finish grading all areas of the site. Rough grade will be within 2" of finish grade. The Landscape Contractor shall be responsible for any grade disturbed by his work.
- 4. The Landscape Contractor shall be responsible for the thorough removal of existing weeds and grass in the areas to be planted, including application(s) of appropriate herbicides before and after plant installation.
- 5. Soil used for planting shall consist of two parts of the existing soil and one part domestic peat moss (or sandy fill in heavy soils), mixed with two lbs. fertilizer per cubic yard. Fertilizer shall be SLOW RELEASE for new plantings.
- 6. Terra—Sorb, or approved equal, shall be incorporated into the planting soil of all trees in <u>sandy soils</u> only at the following rates:

15 gallon containers = one (3 oz.) Handy Pac 30 gallon containers = two (3 oz.) Handy Pacs Up to 3" caliper = one (3 oz.) Handy Pac 4" to 5" caliper = two (3 oz.) Handy Pacs Broadcast 1/2 throughout the planting pit; mix 1/2 with backfill.

All plant beds shall be top-dressed with 3" of pine bark nuggets.


- 7. The Landscape Architect reserves the right to field locate or review flagged locations of any or all plant material.
- All balled and burlapped trees shall be hardened—off at the supplier's for a minimum of 30 days prior to shipping. All suppliers must be approved by the Landscape Architect prior to delivery and installation of the trees; any tree which shows signs of stress shall be replaced immediately at no charge to the Owner.
- All trees will be staked per detail sheet or by another method approved by the Landscape Architect. Mulched tree rings shall encompass guys.
- 10 No substitutions shall be permitted without prior approval from the Landscape Architect.
- 11. Guaranty (from time of job completion and retainage release):

Trees = 1 year


IRRIGATION REQUIREMENTS


WATERING BY HOSE BIB OR BY OWNER TO BE APPROVED BY CITY OF ALACHUA

- 1. TYPE OF AUTOMATED SYSTEM = ELECTRIC CONTROLLER IN OUTDOOR LOCKING CABINET OR INDOORS.
- 2. TYPE AND SIZE OF ELECTRICAL WIRE = TO BE DETERMINED AT FOR VALVES
- 3. BACKFLOW PREVENTION DEVICE = FEBCO 850 DOUBLE CHECK OR PER COUNTY REQUIREMENTS
- 4. REQUIRED OPERATING PRESSURE = 30 PSI / 20 GPM 5. DESIGN OPERATING PRESSURE OF IRRIGATION SYSTEM = 30 PSI
- 6. PLACEMENT OF RAIN SENSOR WILL BE MOUNTED IN OPEN AREA CLOSE TO CONTROLLER
- 7. WATER REQUIREMENTS PER ZONE = PROVIDE 1/4" WATER PER ZONE/DAY (1-3/4"/WEEK), COMPLY WITH DISTRICT WATERING RESTRICTIONS BUBBLERS ZONES (EACH)= RUN TIME 15 MIN.,7 DAYS (FIRST YEAR)= 30 GALLONS/DAY
- 8. SEE SHEET FOR INSTALLATION SPECIFICATIONS AND DETAILS.

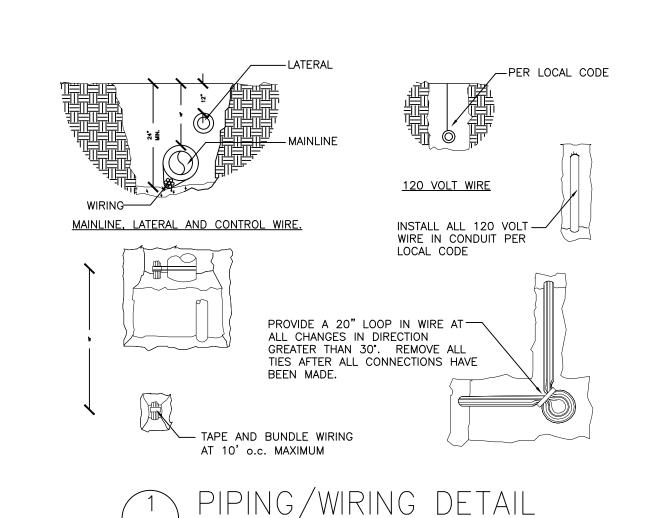

SCALE: NOT TO SCALE

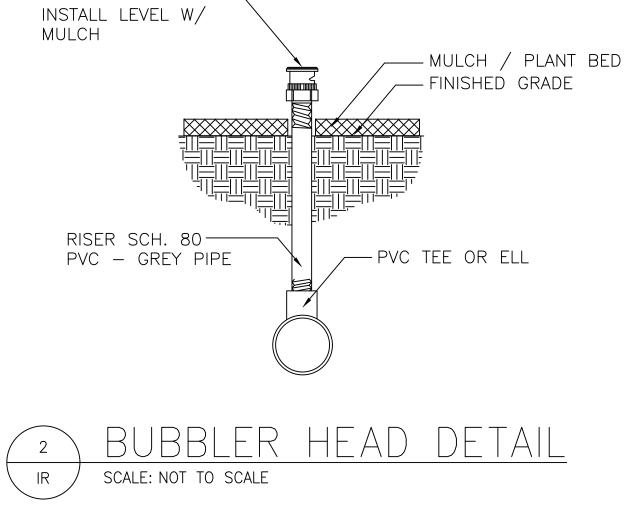

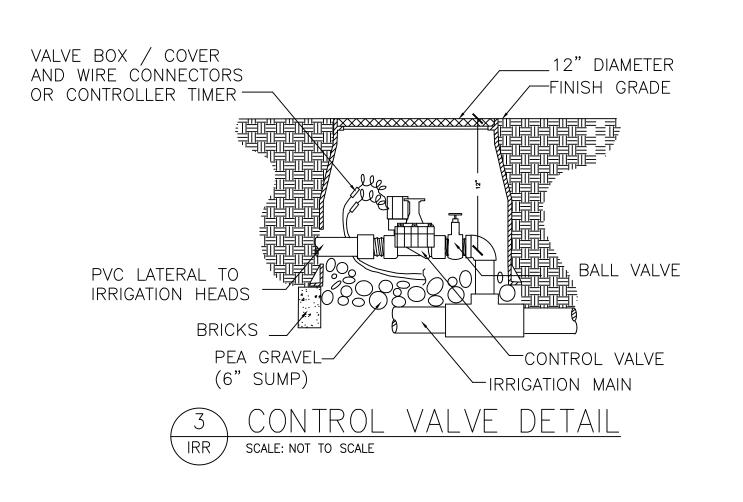


DETAILS

ELIZABETH C. HOUCK
LANDSCAPE ARCHITECTURE, L.
E PLANS * CONSULTATION * CONSTRUCTION DOCUN
ZEBULON, N.C.
(352) 875-8291 (CELL)

7/10 \geq -VIE RE

5 OF 5

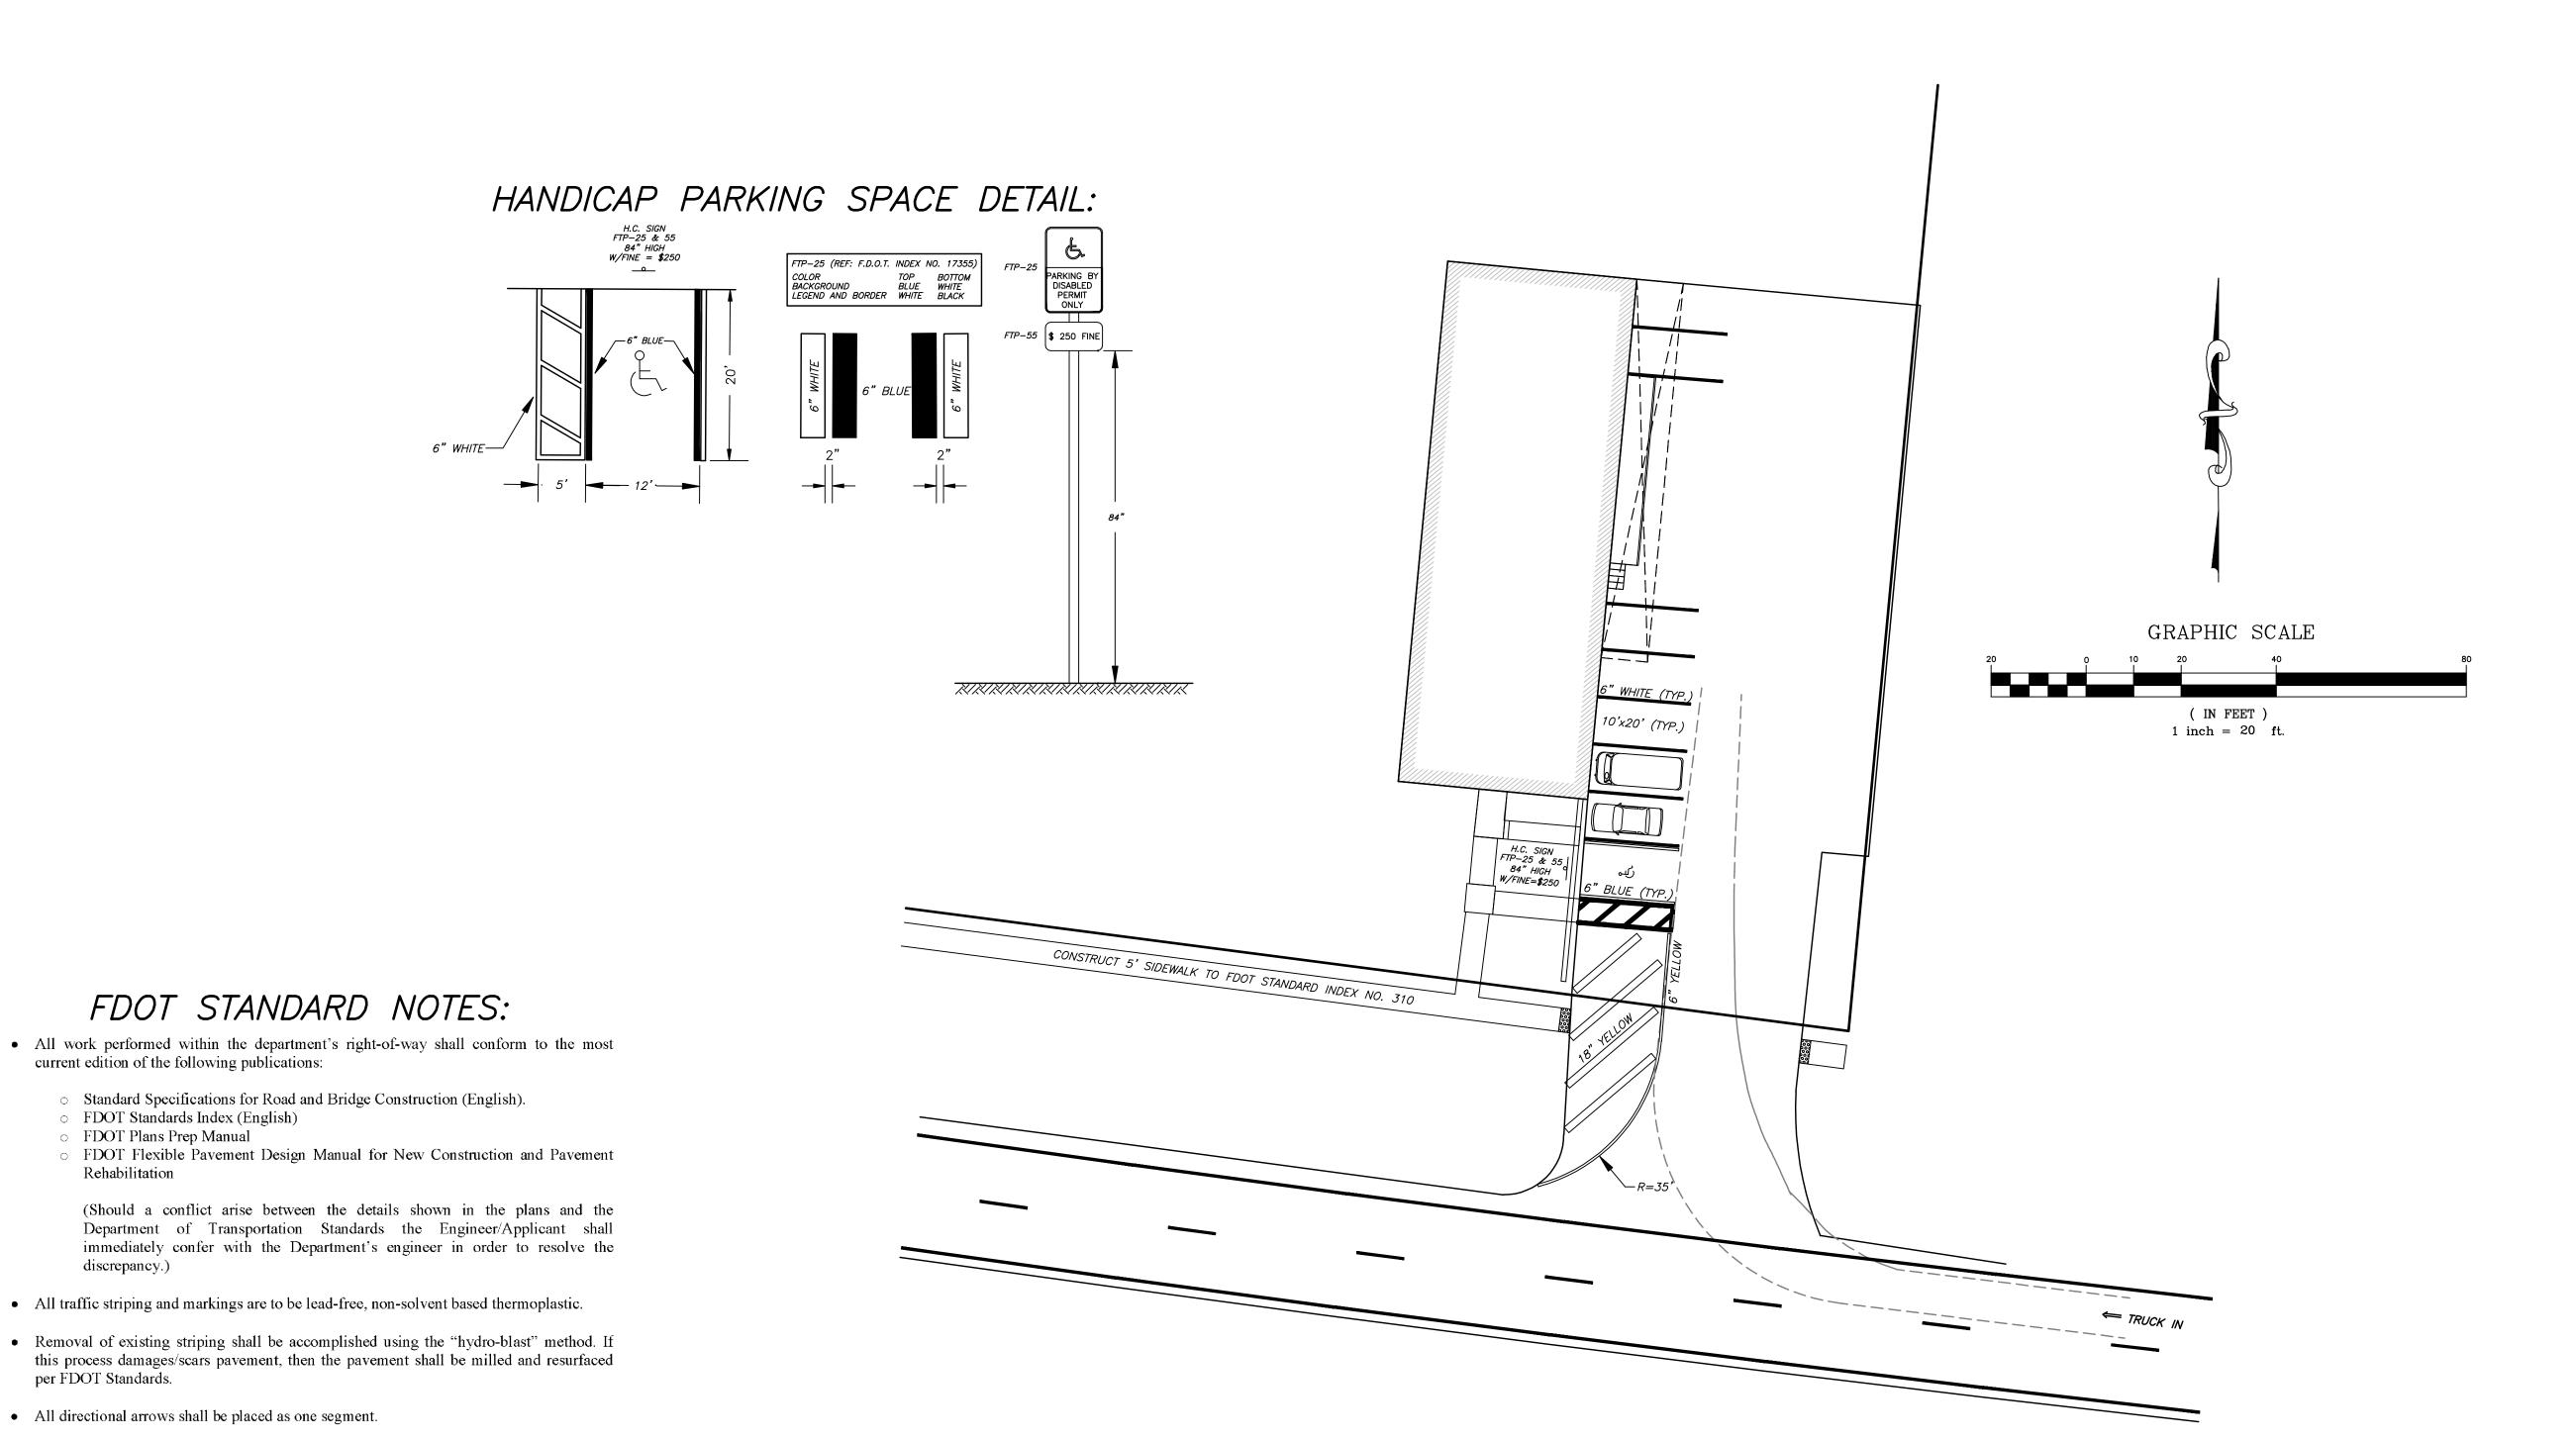

o FDOT Plans Prep Manual

Rehabilitation

discrepancy.)

pavement marking limits of construction.

• Alignment of proposed pavement markings shall match existing pavement markings at

• All disturbed area within the department's right-of-way will restored to original or better condition by grading and sodding the area disturbed (Bermuda in rural, centipede in

• All lanes must be opened for traffic during an evacuation notice of a hurricane or other catastrophic event and shall remain open for the duration of the evacuation or event.


• All curb and gutter and sidewalk will be removed and replaced joint to joint.

• Burning of any material or debris is prohibited in the FDOT right-of-way.

All broken/cracked driveways must be fully removed and replaced.

per FDOT Standards.


utility strips).

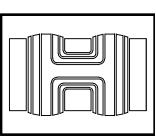

SHEET 1 OF 1

BOUNDARY AND TOPOGRAPHIC SURVEY A PORTION OF TAX PARCEL #03211-001-000 & TAX PARCEL 03211-003-000 14619 N.W. US HIGHWAY 441 NW 150TH AVE ALACHUA, FL 32615 SECTION 14, TOWNSHIP 08 SOUTH, RANGE 18 EAST

ALACHUA COUNTY, FLORIDA

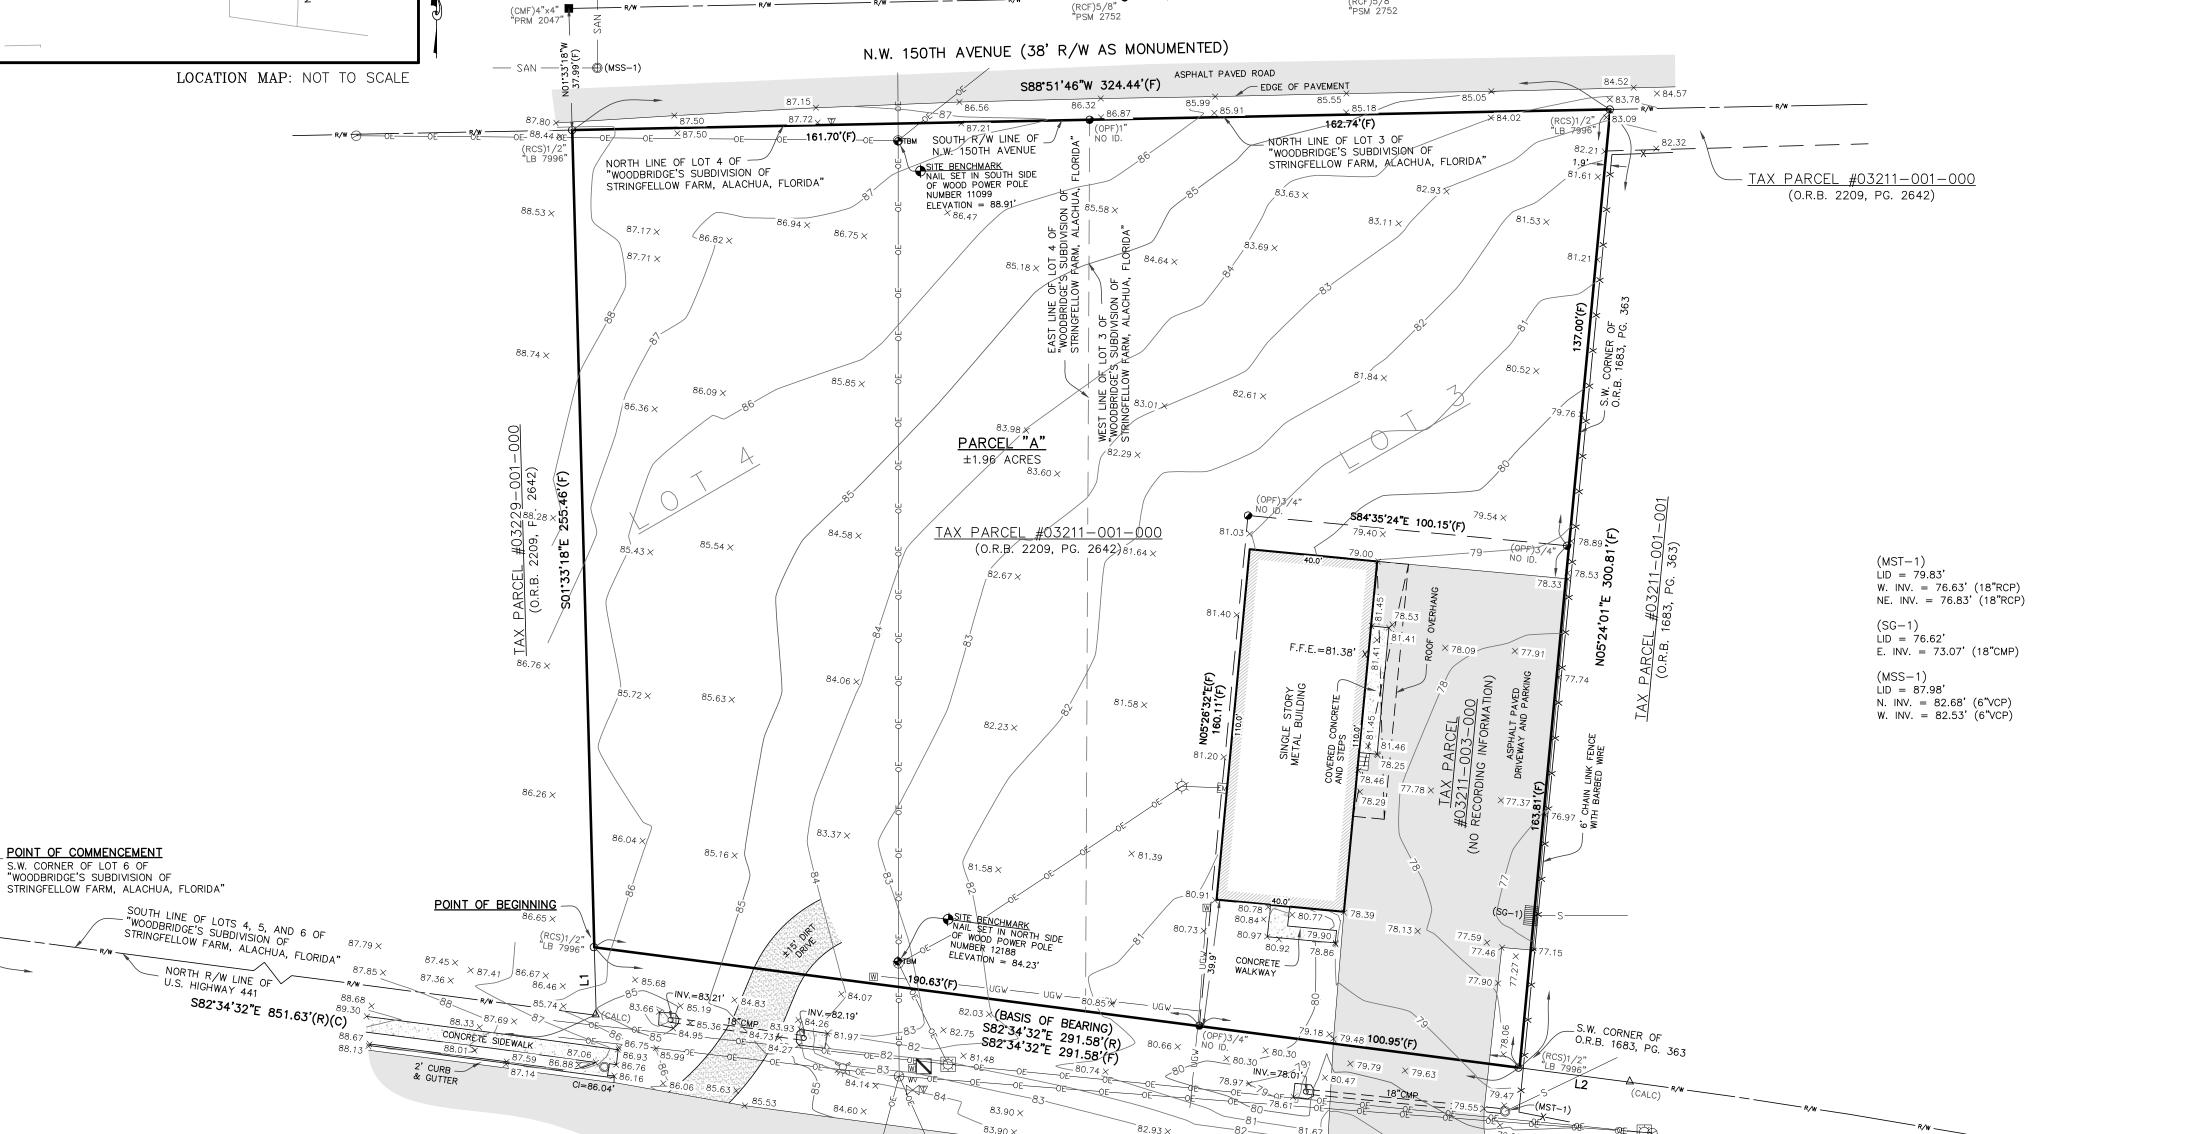

LINE TABLE								
LINE #	LINE BEARING AND DISTANCE							
L1	N01'35'32"W 21.26'(R) N01'33'18"W 21.26'(C)							
L2	S82°34'32"E 34.67'(R) S82°34'32"E 34.67'(C)							

CURVE TABLE									
CURVE #	LENGTH	RADIUS	DELTA	TANGENT	CHORD	BEARING	AND	DISTANCE	
C1	243.31'(C)	2372.86'(R) 2372.86'(C)	05°52'30"(C)	121.76'(C)	S79°35'10"E 24 S79°34'02"E 24		243. 243.	20'(R) 20'(C)	

CERTIFY SURVEY TO: DREYER'S CLEANING & RESTORATION, INC. MEGAHEE ENTERPRISES LTD., LLLP OLD REPUBLIC NATIONAL TITLE INSURANCE COMPANY FISHER, TOUSEY, LEAS & BALL, P.A.

U.S. HIGHWAY 441 - STATE ROAD 20/25 (R/W WIDTH VARIES)

DATE OF BOUNDARY SURVEY: 01-25-2018; 01-31-2018 DATE OF TOPOGRAPHIC SURVEY: 09-23-2019

DATE OF DRAWING: 10-10-2019 DATE OF SIGNATURE:

> SCALE: 1'' = 30'PAGE 1 OF 1 DATE: 10-10-2019 BAR IS ONE INCH ON ORIGINAL DRAWING DRAWN BY: GUY/JAT FIELD BOOK: 357/71-72; 394/01 IF NOT ONE INCH ON THIS SHEET, ADJUST OPYRIGHT © DEREN LAND SCALES ACCORDINGLY SURVEYING, LLC. LB No. 7996

REVISION: (10-10-2019) ADDED TOPOGRAPHIC DATA NO. 6946 PROFESSIONAL SURVEYOR & MAPPER FLA.CERT. 6940

4605 N.W. 6TH STREET, SUITE H GAINESVILLE, FLORIDA 32609



SCALE: 1" = 30

"ACCURACY COUNTS - KNOW YOUR BOUNDARIES"

REVISION: (02-20-2018) CORRECTED PREPARED LAND DESCRIPTION

ACAD 19 - 18030 - 1

PHONE: (352) 331-0010 PHONE: (352) 336-3363 FAX: (352) 336-1084 DERENLANDSURVEYING.COM

US HIGHWAY 441 85.00'(R) N88'51'46"E 85.04'(F) 173.60'(R) N88'51'46"E 173.70'(F)

COMMENCE AT THE SOUTHWEST CORNER OF LOT 6 OF SAID "WOODBRIDGE'S SUBDIVISION OF STRINGFELLOW FARM, ALACHUA, FLORIDA", AND BEING ON THE NORTH RIGHT-OF-WAY LINE OF U.S. HIGHWAY 441 (RIGHT-OF-WAY WIDTH VARIES); THENCE SOUTH 82°34'32" EAST, ALONG THE SOUTH LINE OF LOTS 6, 5, AND 4 OF SAID "WOODBRIDGE'S SUBDIVISION OF STRINGFELLOW FARM, ALACHUA, FLORIDA", AND ALONG SAID NORTH RIGHT-OF-WAY LINE OF U.S. HIGHWAY 441, A DISTANCE OF 851.63 FEET; THENCE, LEAVING SAID SOUTH LINE OF LOTS 6, 5, AND 4, NORTH 01°33'18" WEST, A DISTANCE OF 21.26 FEET TO A 1/2" REBAF & CAP (LB 7996) AND THE POINT OF BEGINNING; THENCE, CONTINUE ALONG SAID NORTH RIGHT-OF-WAY LINE OF U.S. HIGHWAY 441, SOUTH 82°34'32" EAST, A DISTANCE OF 291.58 FEET TO A 1/2" REBAR & CAF MARKING THE SOUTHWEST CORNER OF THAT PARCEL OF LAND AS DESCRIBED IN OFFICIAL RECORDS BOOK 1683, PAGE 363; THENCE, LEAVING SAID NORTH RIGHT-OF-WAY LINE, NORTH 05°24'01" EAST, ALONG THE WEST LINE OF SAID PARCEL OF LAND AND ALONG THE NORTHERLY PROJECTION THEREOF, A DISTANCE OF 300.81 FEET TO A 1/2" REBAR & CAP (LB 7996) ON THE NORTH LINE OF LOT 3 OF SAID "WOODBRIDGE'S SUBDIVISION OF STRINGFELLOW FARM, ALACHUA, FLORIDA", AND BEING ON THE SOUTH RIGHT-OF-WAY LINE OF N.W. 150TH AVENUE (38 FOOT RIGHT-OF-WAY AS MONUMENTED); THENCE SOUTH 88°51'46" WEST, ALONG THE NORTH LINE OF SAID LOTS 3 AND 4, AND ALONG SAID SOUTH RIGHT-OF-WAY LINE OF N.W. 150TH AVENUE, A DISTANCE OF 324.44 FEET TO A 1/2" REBAR & CAP (LB 7996); THENCE, LEAVING SAID NORTH AND SOUTH LINES, SOUTH 01°33'18" EAST, A DISTANCE OF 255.46 FEET TO THE POINT OF BEGINNING. CONTAINING 1.96 ACRES, MORE OR LESS.

A PARCEL OF LAND LOCATED IN SECTION 14, TOWNSHIP 08 SOUTH, RANGE 18 EAST, ALACHUA COUNTY,

FLORIDA, BEING A PORTION OF LOTS 3 AND 4 OF "WOODBRIDGE'S SUBDIVISION OF STRINGFELLOW FARM,

ALACHUA, FLORIDA", AS RECORDED IN PLAT BOOK "C", PAGE 68-A, OF THE PUBLIC RECORDS OF ALACHUA

SURVEYOR'S NOTES:

1. SURVEY BASED ON MONUMENTATION FOUND AND ACCEPTED AND ON "WOODBRIDGE'S SUBDIVISION OF STRINGFELLOW FARM ALACHUA, FLORIDA" AS RECORDED IN PLAT BOOK "C", PAGE 68-4 OF THE PUBLIC RECORDS OF ALACHUA COUNTY, FLORIDA. 2. BEARINGS ARE BASED ON A RECORDED CALL OF SOUTH 82°34'32" EAST FOR THE NORTH RIGHT-OF-WAY LINE OF U.S. HIGHWAY 441 AS RECORDED IN OFFICIAL RECORDS BOOK 2039, PAGE 2756.

3. LAND DESCRIPTION WAS PREPARED BY THIS FIRM.

LAND DESCRIPTION: PARCEL "A" (PREPARED BY THIS FIRM)

COUNTY, FLORIDA, MORE PARTICULARLY DESCRIBED AS FOLLOWS:

4. VERTICAL DATUM IS BASED ON NAVD 1988 AS ESTABLISHED BY TRIMBLE "VRS NOW" GPS SURVEY NETWORK USING FLORIDA DEPARTMENT OF TRANSPORTATION VERTICAL CONTROL POINTS "175 E 1" AND "175 D 1".

5. THE DIGITAL SIGNATURE AND SEAL AS SHOWN ON THIS SURVEY ARE ONLY VALID FOR THIS ELECTRONIC PDF SURVEY FILE. 6. THE PRINTED SURVEY AND REPRODUCTIONS THEREOF ARE NOT VALID WITHOUT THE SIGNATURE AND ORIGINAL RAISED SEAL OF A FLORIDA LICENSED SURVEYOR AND MAPPER.

7. UNLESS NOTED, NO UNDERGROUND INSTALLATIONS OR IMPROVEMENTS WERE LOCATED FOR THIS SURVEY.

8. NO INSTRUMENTS OF RECORD REFLECTING EASEMENTS, RIGHT-OF-WAYS, AND/OR OWNERSHIP WERE FURNISHED TO THIS SURVEYOR EXCEPT AS SHOWN.

9. ONLY ABOVE GROUND UTILITIES WERE LOCATED FOR THIS SURVEY.

10. NORTH ARROW IS BASED ON BEARING STRUCTURE.

11. CERTIFICATION IS NOT TRANSFERABLE.

12. THE PURPOSE OF THIS SURVEY IS TO SHOW BOUNDARY INFORMATION AND IMPROVEMENTS. IT IS NOT TO BE USED FOR ARCHITECTURAL, ENGINEERING, DESIGN OR CONSTRUCTION PURPOSES.

13. FENCES, SYMBOLS, MONUMENTATION AND UTILITIES SHOWN HEREON MAY BE EXAGGERATED FOR PICTORIAL PURPOSES ONLY AND MAY NOT BE SHOWN TO SCALE.

14. COPIES AND ELECTRONIC FILES OF THIS SURVEY ARE ONLY AVAILABLE TO THE CLIENT FOR 90 DAYS FROM THE DATE OF SIGNATURE. AFTER 90 DAYS, A MINIMUM FEE OF 50% OF THE ORIGINAL SURVEY COST WILL BE ASSESSED.

15. THIS SURVEY COMPLIES WITH THE FLORIDA STANDARDS OF PRACTICE AS SET FORTH BY THE FLORIDA BOARD OF PROFESSIONAL LAND SURVEYORS IN CHAPTER 5J-17 FLORIDA ADMINISTRATIVE CODE PURSUANT TO SECTION 472.027 FLORIDA STATUTES.

16. THIS SURVEY WAS PREPARED WITHOUT THE PRIVILEGE OF TITLE OR OWNERSHIP INFORMATION, AND AS SUCH IS SUBJECT TO ANY AND ALL LAND RIGHTS THAT AN ACCURATE TITLE SEARCH WILL REVEAL. THIS SURVEYOR IS NOT LIABLE FOR ANY ERRORS CAUSED BY LACK OF THIS INFORMATION OR OMISSIONS FROM THIS SURVEY THAT SAID TITLE RESEARCH WOULD

FLOOD ZONE:

IT IS THE OPINION OF THIS LAND SURVEYOR BASED ON AN INTERPRETATION OF F.I.R.M. PANEL No. 140 OF 640, COMMUNITY PANEL No. "120664 0140 D" THAT THIS PROPERTY IS LOCATED IN FLOOD ZONE "X", (AREAS DETERMINED TO BE OUTSIDE THE 0.2% ANNUAL CHANCE FLOOD PLAIN), MAP EFFECTIVE DATE JUNE 16, 2006.

LEGEND:

(R) RECORD MEASUREMENT (F) FIELD MEASUREMENT (C) CALCULATED MEASUREMENT ID. IDENTIFICATION R/W RIGHT-OF-WAY O.R.B. OFFICIAL RECORDS BOOK

PG. PAGE F.F.E. FINISHED FLOOR ELEVATION CI CURB INLET RCP REINFORCED CONCRETE PIPE CMP CORRUGATED METAL PIPE

VCP VITRIFIED CLAY PIPE INV. INVERT △ (CALC) CALCULATED CORNER O (RCS) REBAR & CAP SET


• (RCF) REBAR & CAP FOUND • (IRF) IRON ROD FOUND ■ (CMF) CONCRETE MONUMENT FOUND

(OPF) OPEN PIPE FOUND CONCRETE LIGHT POLE WOOD LIGHT POLE ■ WATER METER

WATER VALVE (SG) STORM GRATE ELECTRIC TRANSFORMER (MST) STORM WATER MANHOLE ⊕ (MSS) SANITARY SEWER MANHOLE

▼ TELEPHONE PEDESTAL ■ ELECTRIC METER ----OE------OE---------OVERHEAD ELECTRIC LINES ----- UGW----- UNDERGROUND WATER

DAVID M. DEREN P.S.M.

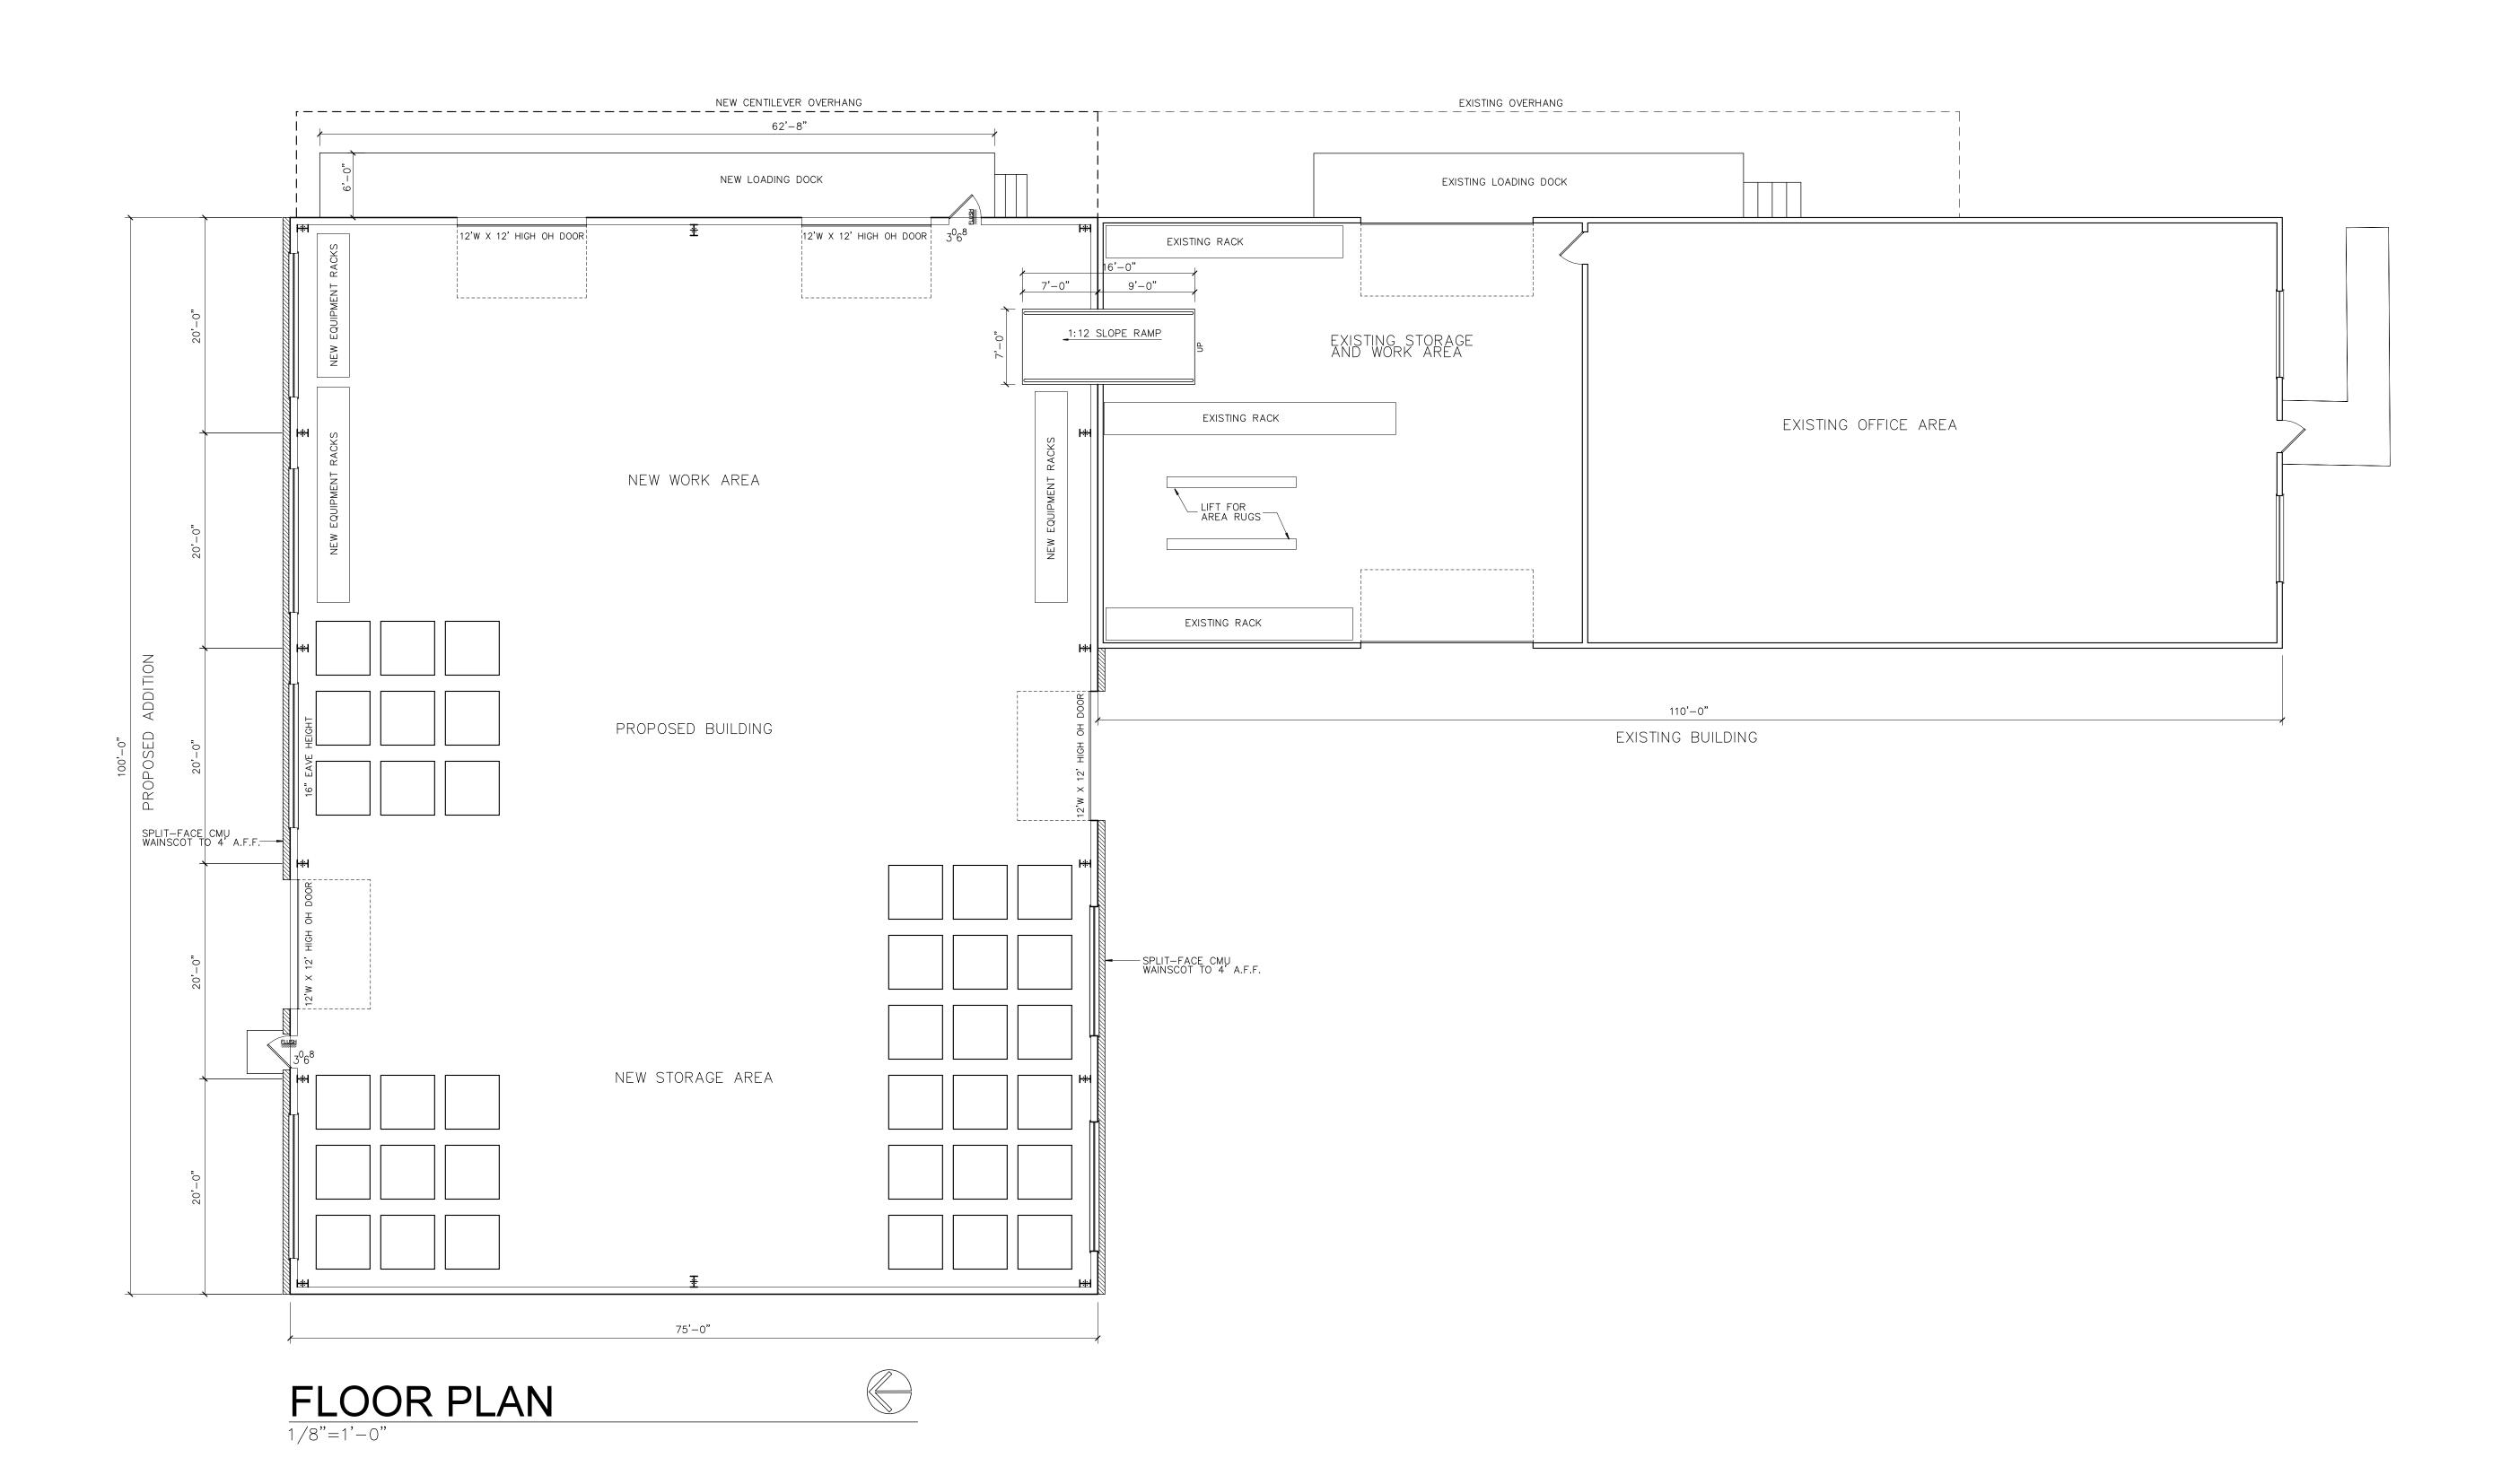

SHATKIN.NET

AR 95609

352-222-3443

WILE, FL 32608

NETAL BUILDING ADDITION

REYER'S DKI

OUS-441 Alachua Florida

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REVISED: 12-4-2019 12-11-2019

PROJECT: SA-1949
DRAWN BY: J.W.S.
CHECKED:
DATE: 9-17-2019

A1.0



SHA ARCHI

NEW METAL BUILDING ADDITION

DREYER'S DKI
14619 N. US-441, Alachua, Florida


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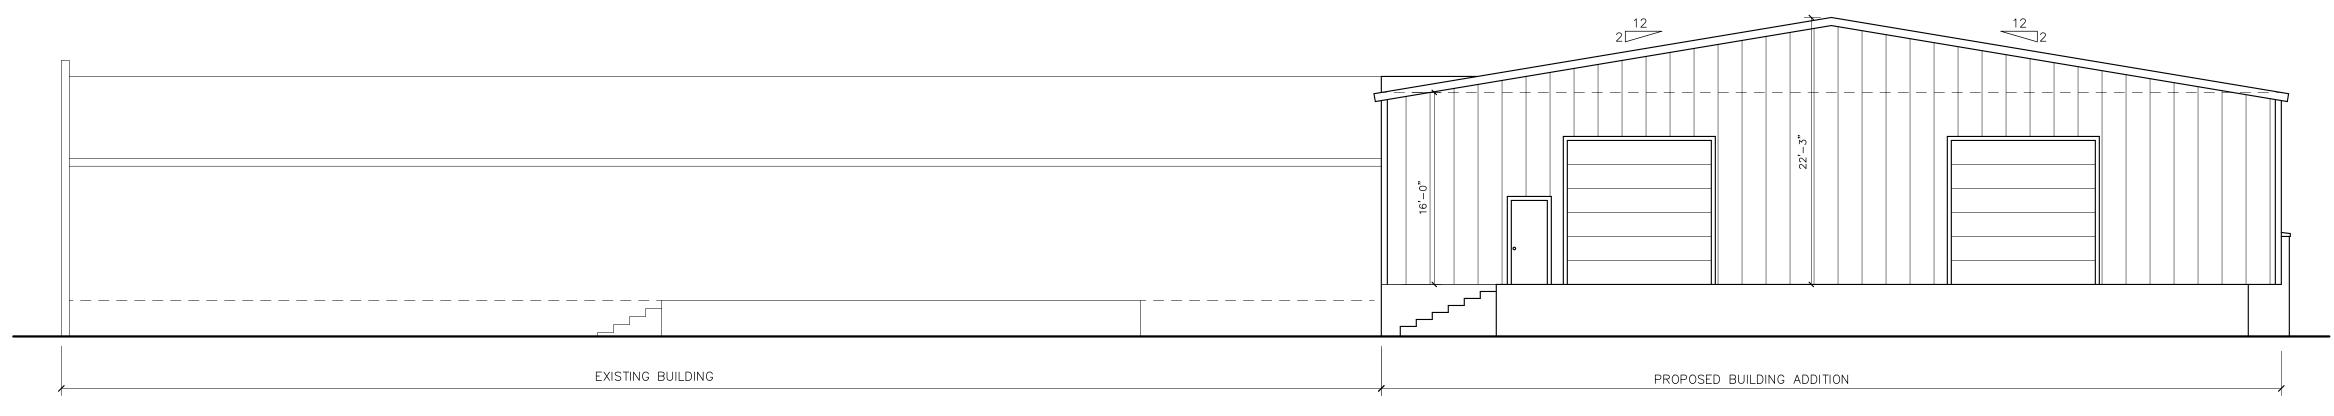
PROJECT: SA-1949
DRAWN BY: J.W.S.

Δ2 (

DATE: 9-17-2019

CHECKED:



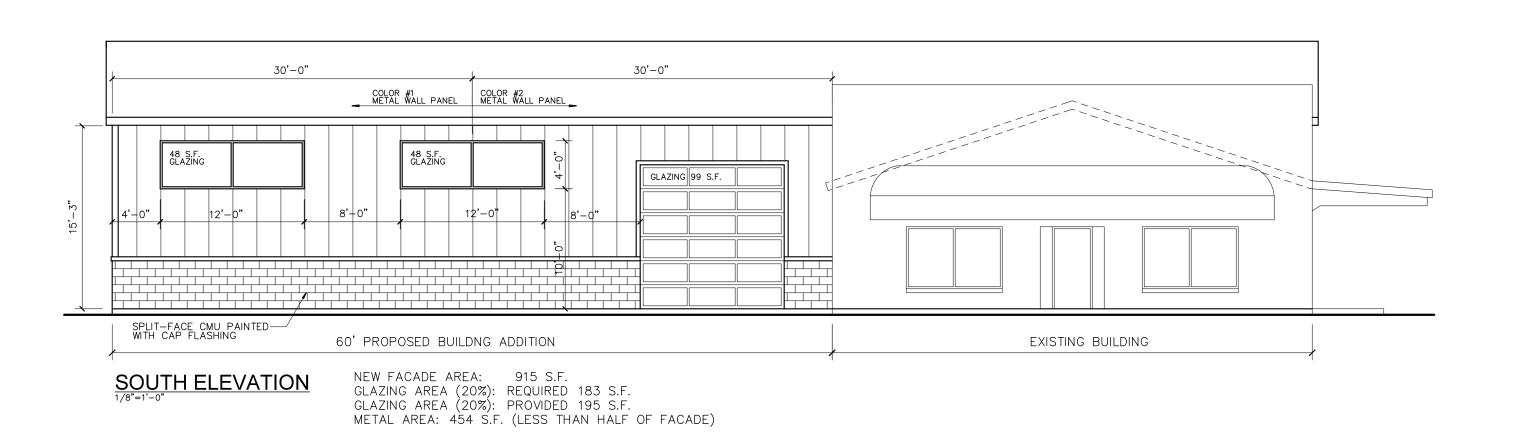

EAST ELEVATION

